
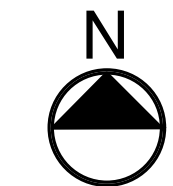


1 MAIN FLOOR PLAN
SCALE: 1/4" = 1'-0"

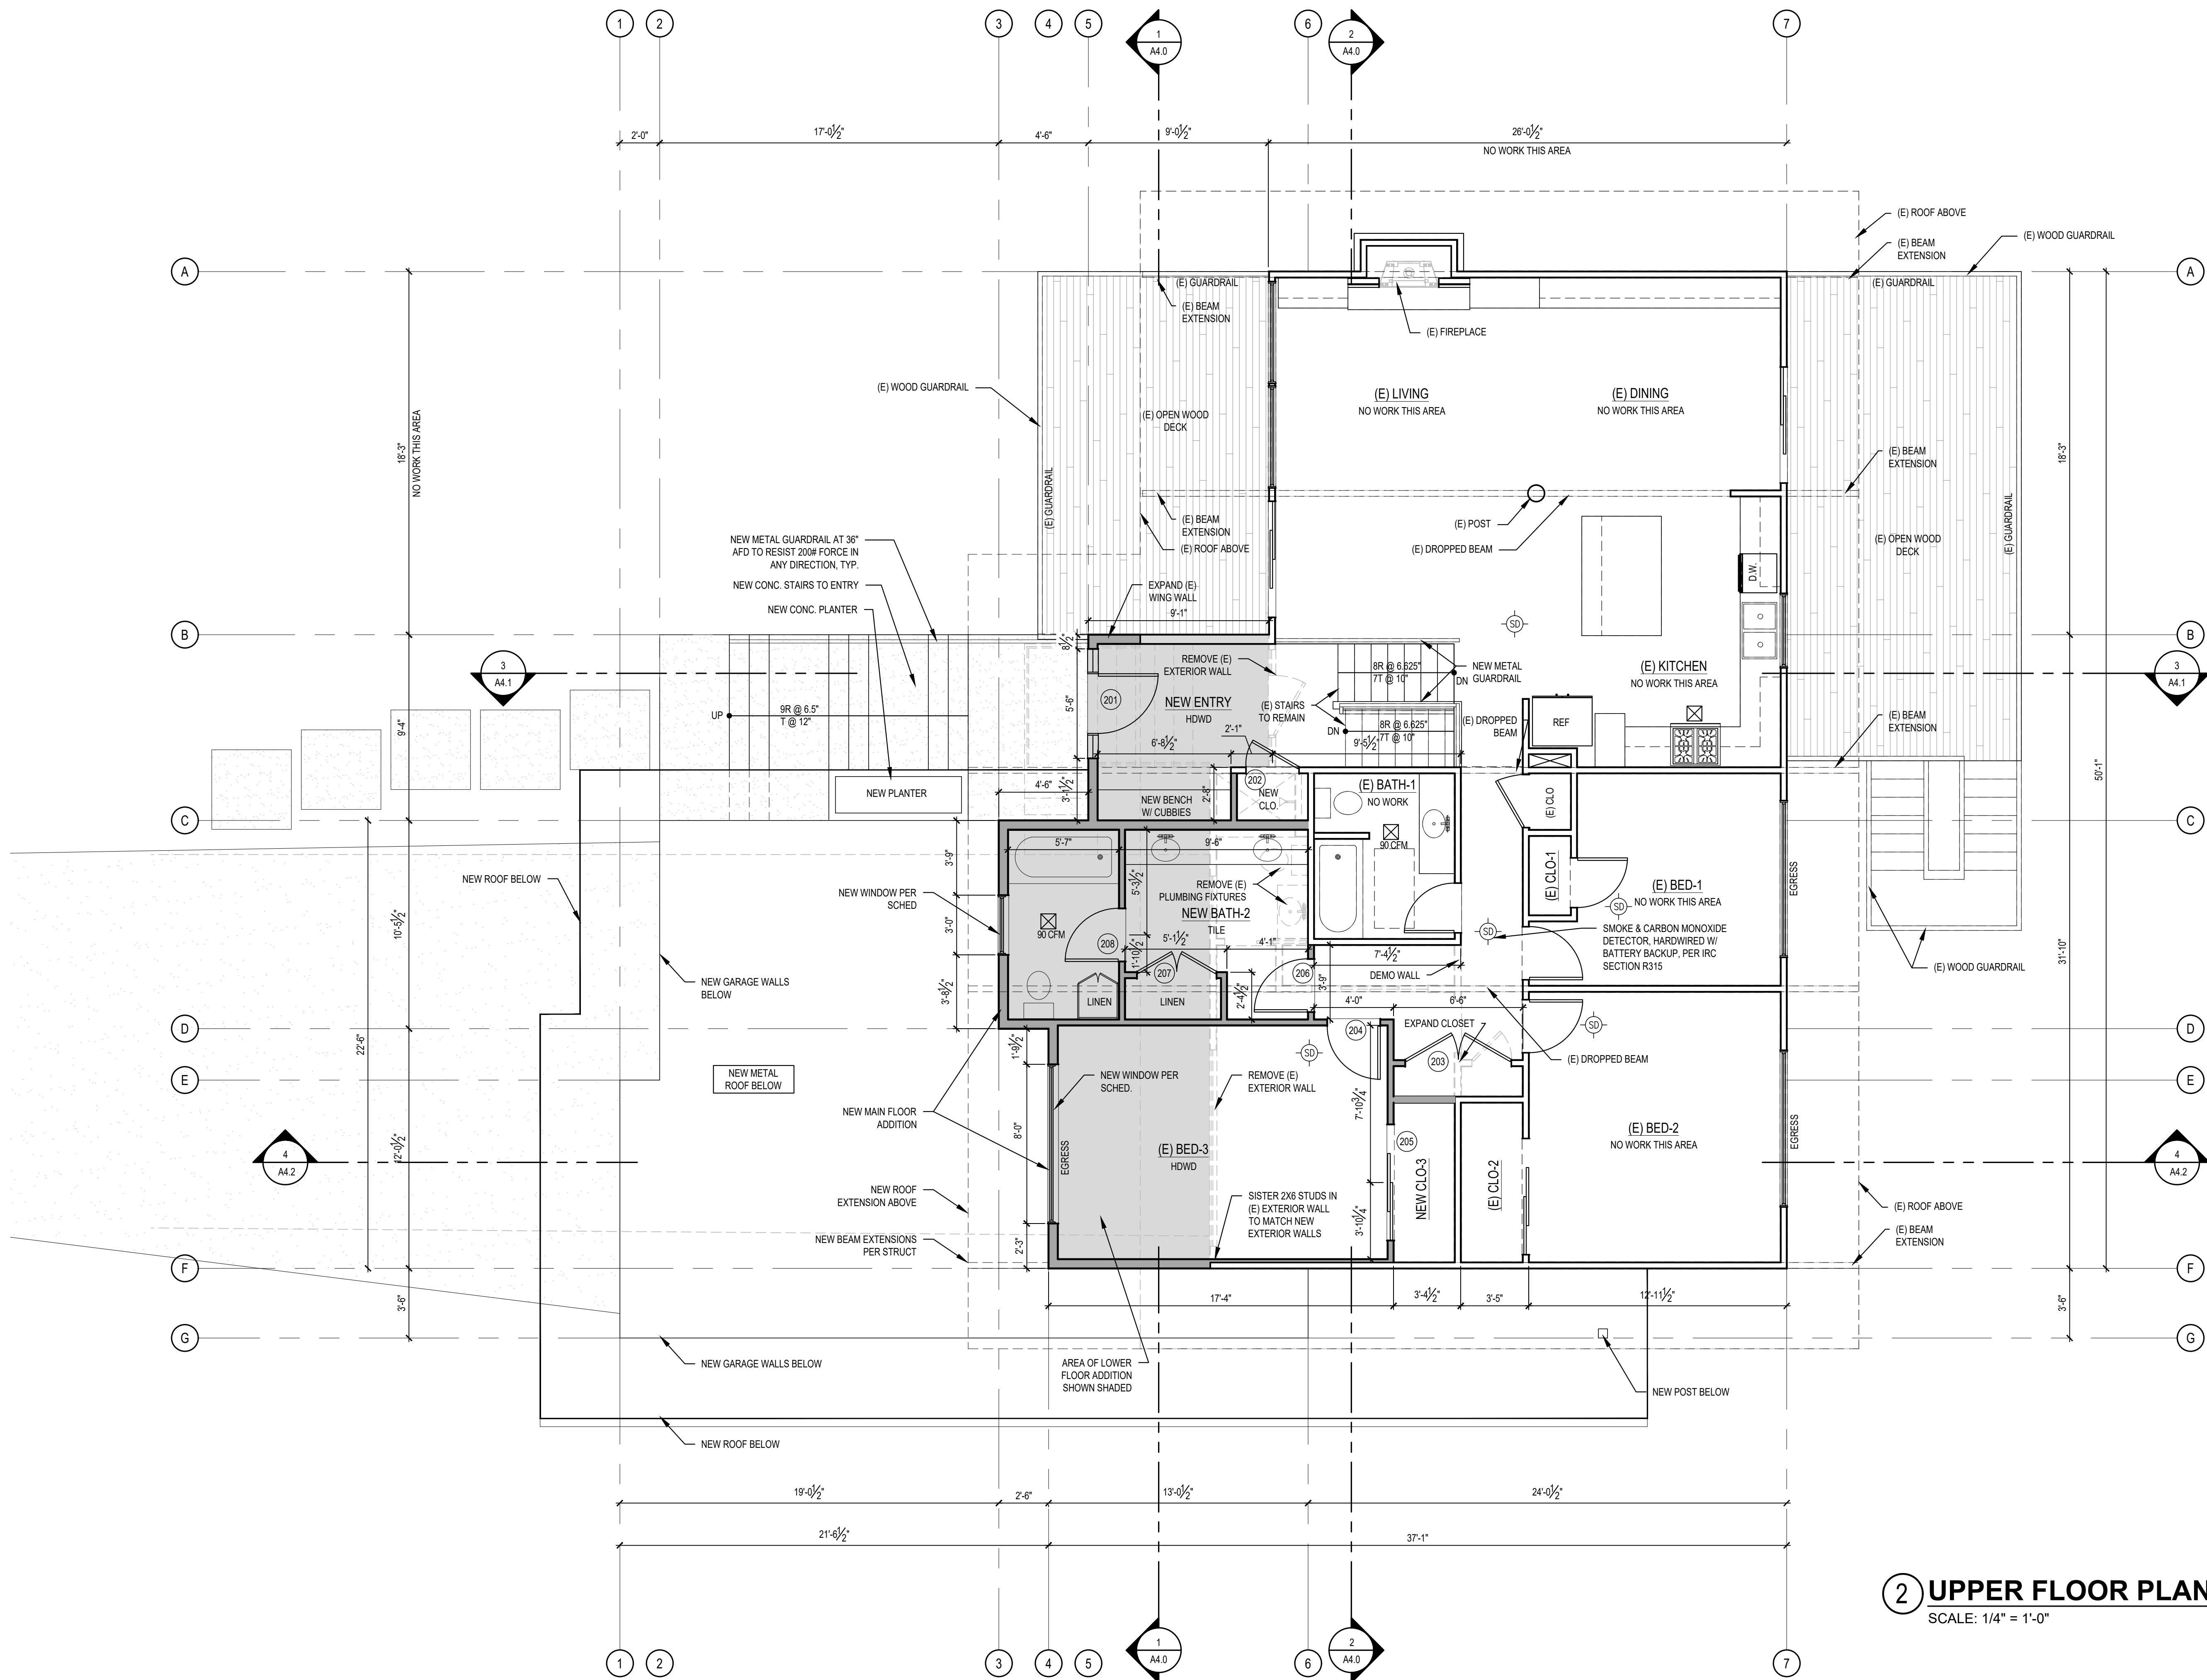

SCALE: IF SHEET IS LESS THAN 24" x 36", IT IS A REDUCED PRINT, REDUCE SCALE ACCORDINGLY
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2 UPPER FLOOR PLAN
SCALE: 1/4" = 1'-0"

SCALE: IF SHEET IS LESS THAN 24" x 36", IT IS
A REDUCED PRINT, REDUCE SCALE ACCORDINGLY
PERMIT SET 05/18/20
PLOT DATE: 5/18/2020 FILE NAME:


WINDOW SCHEDULE

WINDOW MARK	DESCRIPTION	R.O. SIZE WIDTH HEIGHT	TEMP.	QTY.	TOTAL AREA (SF)	U-VALUE (MIN.)	NFRC CERT.	GLAZING	REMARKS & NOTES
A	FIXED	5'-6" 6'-8 3/4"	-	1	35.7	.30	Y	LOW E / CLEAR	-
B	CASEMENT	3'-0" 3'-0"	Y	1	9.0	.30	Y	LOW E / CLEAR	-
C	CASEMENT	2'-0" 3'-6"	-	2	14.0	.30	Y	LOW E / CLEAR	EGRESS
D	FIXED	4'-0" 3'-6"	-	1	14.0	.30	Y	LOW E / CLEAR	-
E	FIXED	5'-0" 3'-0"	-	1	14.2	.30	Y	LOW E / CLEAR	-
F	SLIDER	6'-0" 3'-0"	-	1	17.0	.30	Y	LOW E / CLEAR	EGRESS
G	FIXED	3'-0" 3'-0"	-	1	9.0	.30	Y	LOW E / CLEAR	-

DOOR SCHEDULE

DOOR NO.	LOCATION	SIZE WIDTH HEIGHT	DOOR TYPE	TEMP. GLASS	DOOR FIN.	DOOR THK.	U-VAL. (MIN.)	NFRC CERT.	DOOR HDWR.	REMARKS & NOTES
MAIN FLOOR										
101	GARAGE	9'-0" 8'-0"	C	-	-	1-3/4"	.30	Y	-	-
102	GARAGE	9'-0" 8'-0"	C	-	-	1-3/4"	.30	Y	-	-
103	STORAGE	6'-0" 6'-8"	B	-	-	1-3/4"	.30	Y	-	-
104	MUD ROOM	2'-10" 6'-8"	D	-	-	1-3/4"	.30	Y	-	-
105	MUD ROOM	2'-8" 6'-8"	D	-	-	1-3/4"	.30	Y	-	-
106	MUD ROOM	2'-10" 6'-8"	F	-	-	1-3/4"	.30	Y	-	-
107	BATH	2'-8" 6'-8"	A	-	-	1-3/4"	.30	Y	-	-
108	REC ROOM	5'-4" 6'-8"	A	-	-	1-3/4"	.30	Y	-	-
109	REC ROOM	5'-8" 6'-8"	A	-	-	1-3/4"	.30	Y	-	-
110	GARAGE	2'-10" 6'-8"	D	-	-	1-3/4"	.30	Y	-	-
UPPER FLOOR										
201	ENTRY	3'-0" 6'-8"	D	-	-	1-3/4"	.30	Y	-	-
202	CLOSET	2'-8" 6'-8"	A	-	-	1-3/4"	.30	Y	-	-
203	HALLWAY CLOSET	5'-4" 6'-8"	E	-	-	1-3/4"	.30	Y	-	-
204	BED-3	2'-8" 6'-8"	A	-	-	1-3/4"	.30	Y	-	-
205	BED-3	5'-10" 6'-8"	G	-	-	1-3/4"	.30	Y	-	-
206	BATH-2	2'-8" 6'-8"	A	-	-	1-3/4"	.30	Y	-	-
207	BATH-2 LINEN	4'-0" 6'-8"	E	-	-	1-3/4"	.30	Y	-	-
208	BATH-2	2'-6" 6'-8"	A	-	-	1-3/4"	.30	Y	-	-

DOOR TYPES:

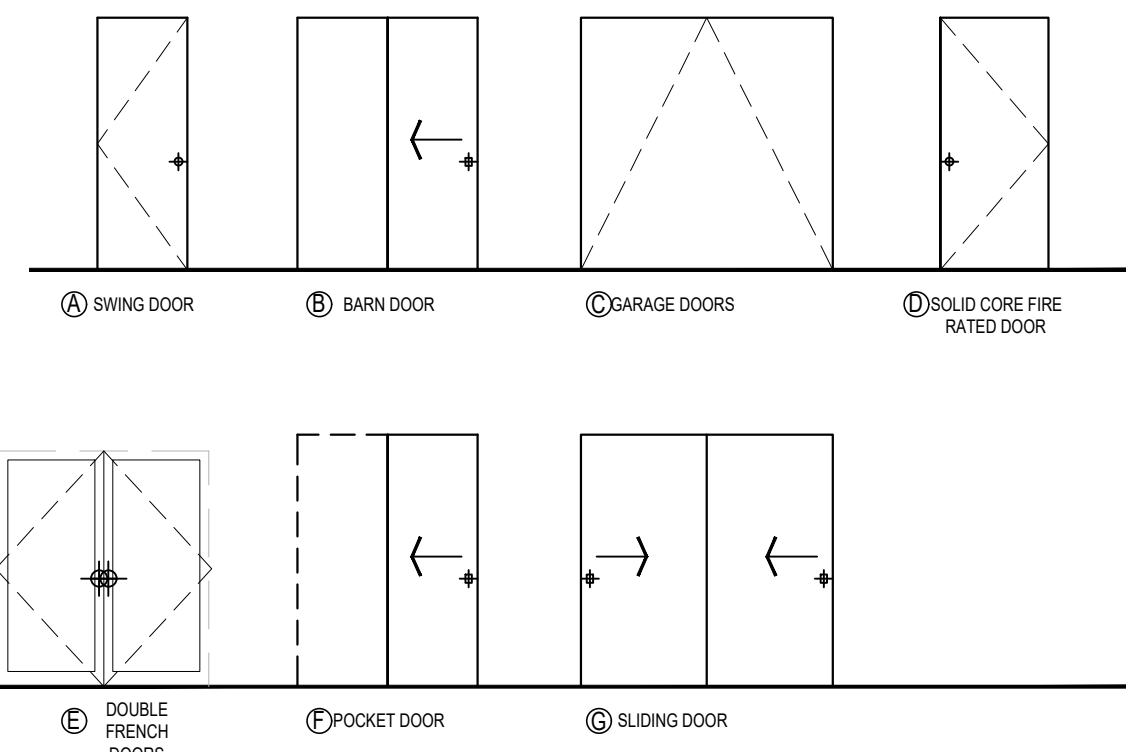

WINDOW & DOOR SCHEDULE NOTES:

- CONTRACTOR TO VERIFY ALL GLAZING SIZING, AND DOOR DIMENSIONS IN FIELD PRIOR TO ROUGH FRAMING & ORDERING OF GLAZING WINDOW/DOOR MATERIALS. REVIEW SIZES AND ANY DISCREPANCIES W/ ARCHITECT.
- ALL GLAZING TO BE "LOW E", INSULATED GLASS UNLESS NOTED OTHERWISE.
- ALL OPERABLE WINDOWS TO HAVE SCREENS.
- GLAZING INDOORS AND/OR WITHIN 24" OF A DOOR TO BE TEMPERED. SEE EXTERIOR ELEVATION FOR TEMP. GLASS LOCATION & EGRESS WINDOWS.
- 2015 WSEC & VIAQ RESIDENTIAL PRESCRIPTIVE OPTION 3 ADOPTED. GLAZING AREA INDICATED UNLIMITED. SEE ENERGY NOTE AT A1.0 SHEET FOR DETAILS.
- ALL WINDOWS AND DOORS WITHOUT A BUG ARE EXISTING TO REMAIN.

ABBREVIATIONS:


- ALUM ALUMINUM
- MC METAL CLAD
- PRE-FIN PRE-FINISHED
- PNT PAINTED
- SCW SOLID CORE WOOD
- WD WOOD

ROOF VENT CALCULATIONS

DESCRIPTION	SF AREA	REQ. VENTING PER SF AREA		CALCULATIONS		X	VENT L.F.	=	TOTAL VENT AREA SQ. IN.	X	SF CONVERT. 1/144	X	ACTUAL 80% EFF FACTOR	
		150	300	VENT TYPE	SOFFIT								TOTAL	TOTAL
ROOF A	2438	8.13	12 SQ. IN./FT. 1.5" VENT	RIDGE	18 SQ. IN./FT. 1.5" VENT	44.75	179.5	=	537	3.73	22.44	X	17.95	20.93
				SOFFIT	18 SQ. IN./FT. 1.5" VENT								8.85	8.85
ROOF B	1,012	3.37	12 SQ. IN./FT. CONTINUOUS				88.5	=	0	0.00		X	0.00	0.00

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3 ROOF PLAN
SCALE: 1/4" = 1'-0"


STURMAN ARCHITECTS
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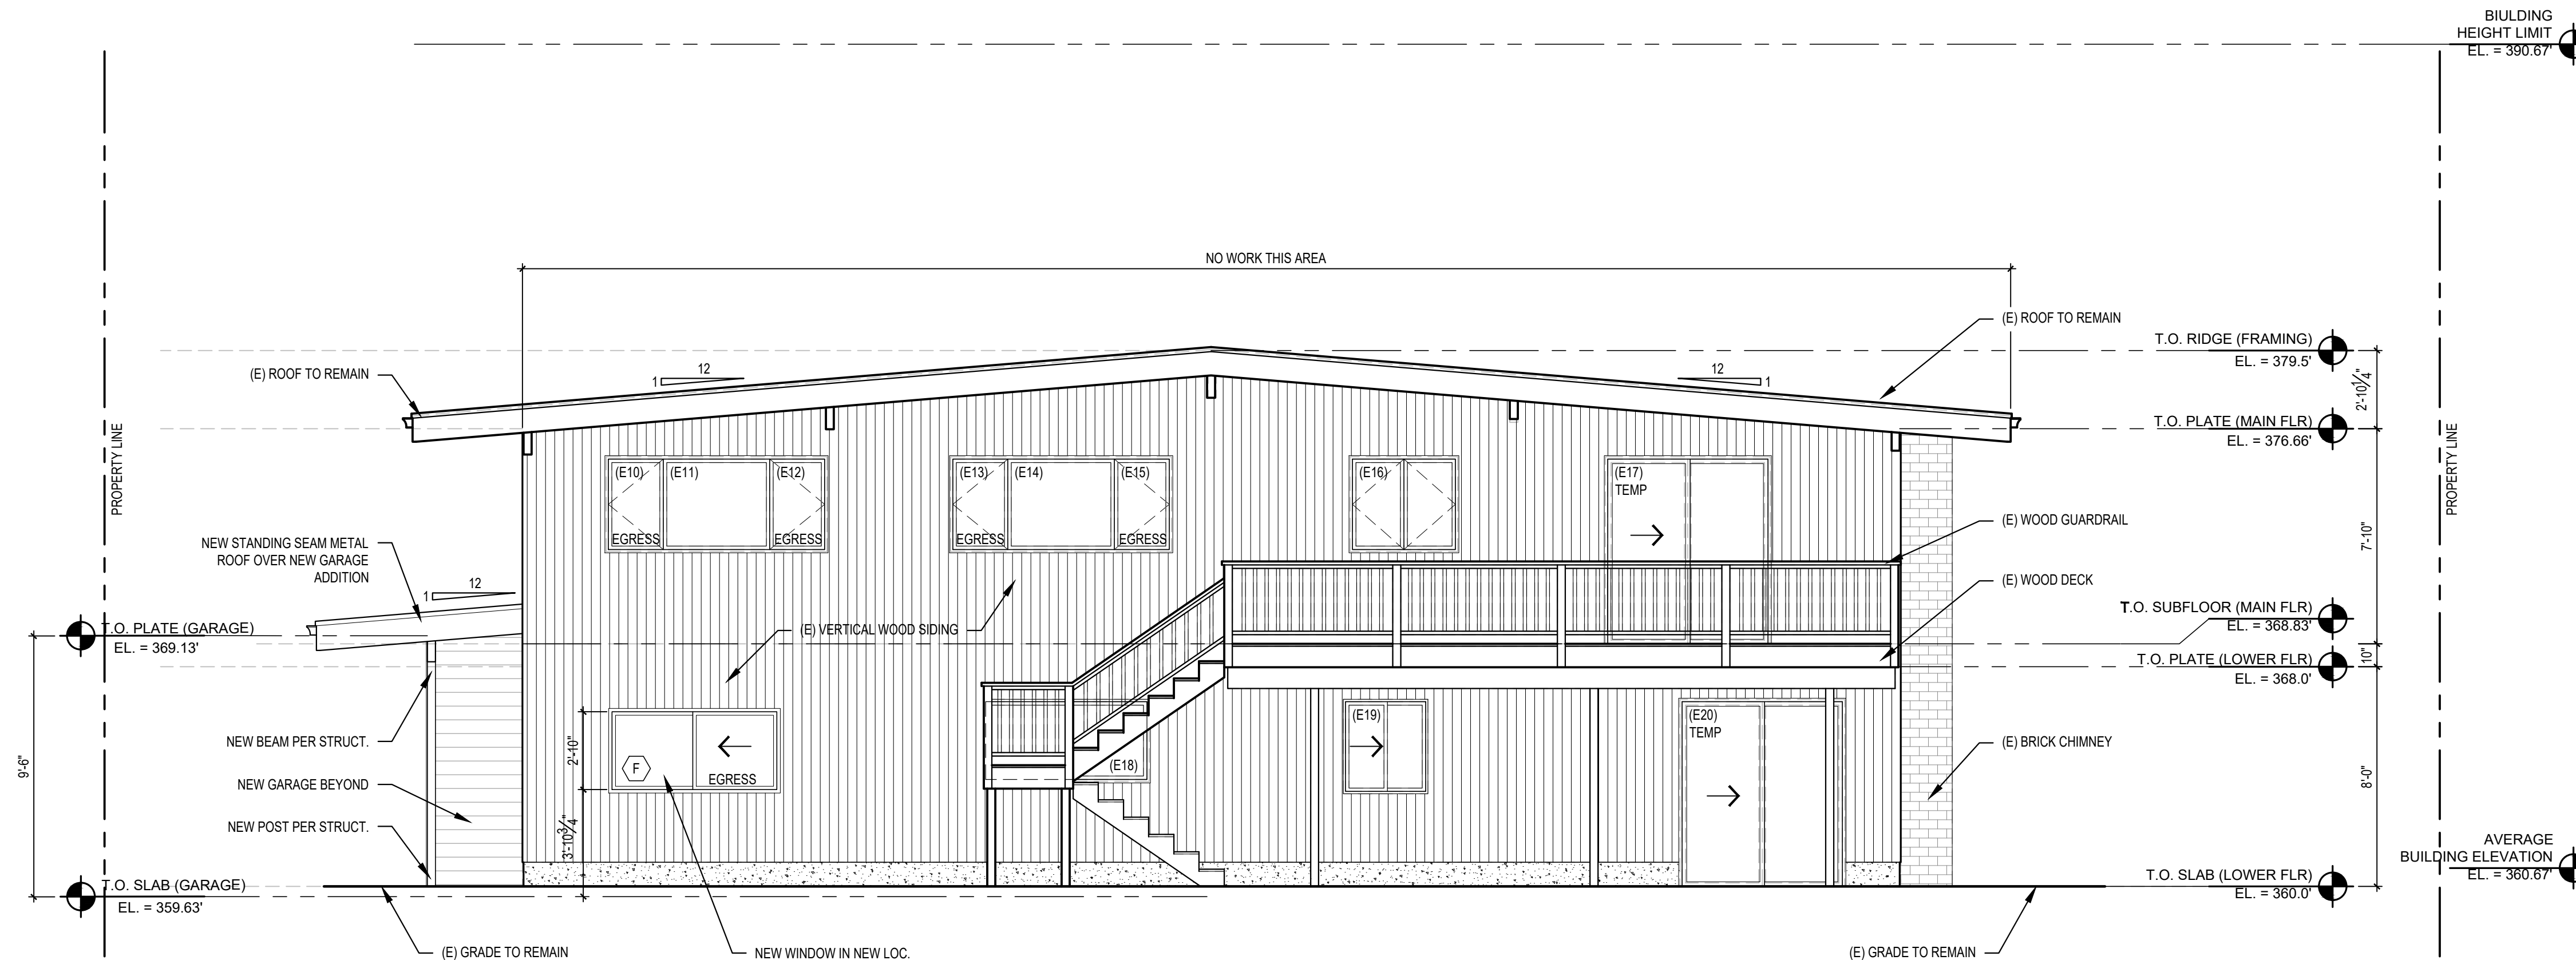
ROOF PLAN

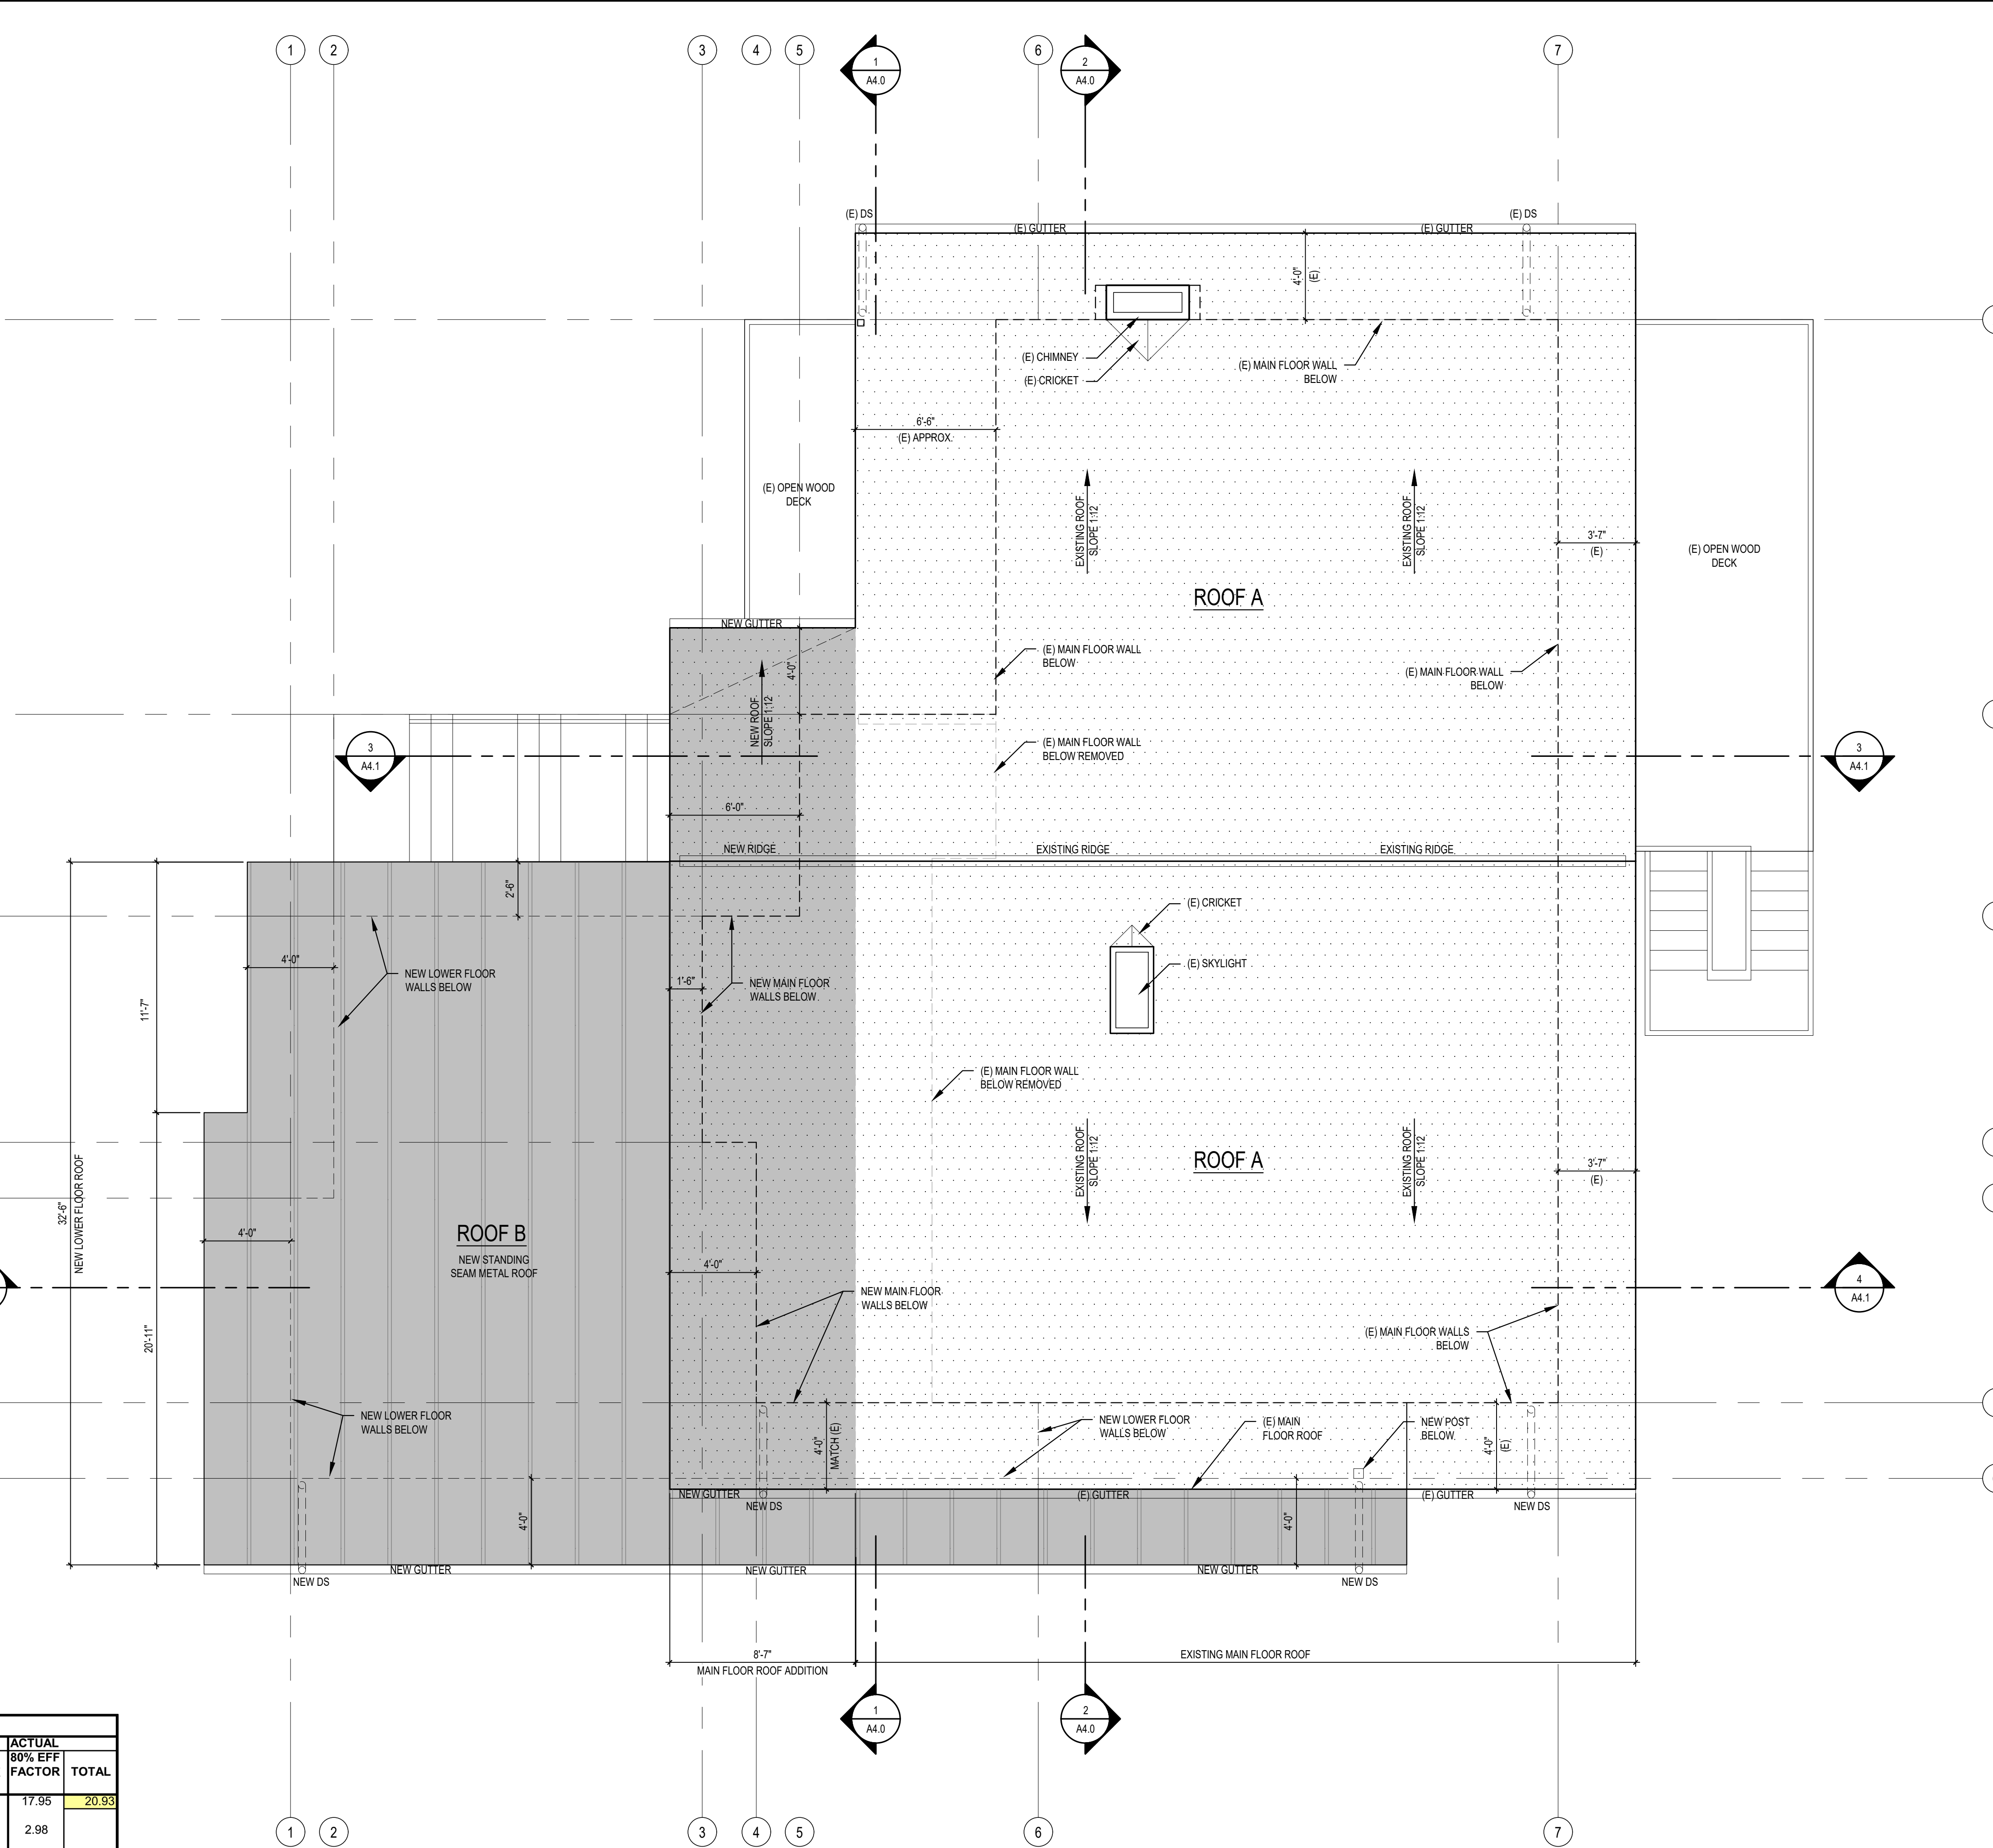REVISIONS:
DRAWN BY: KE
CHECKED BY: BUS
SHEET **A2.2** OF



① WEST ELEVATION

SCALE: 1/4" = 1'-0"

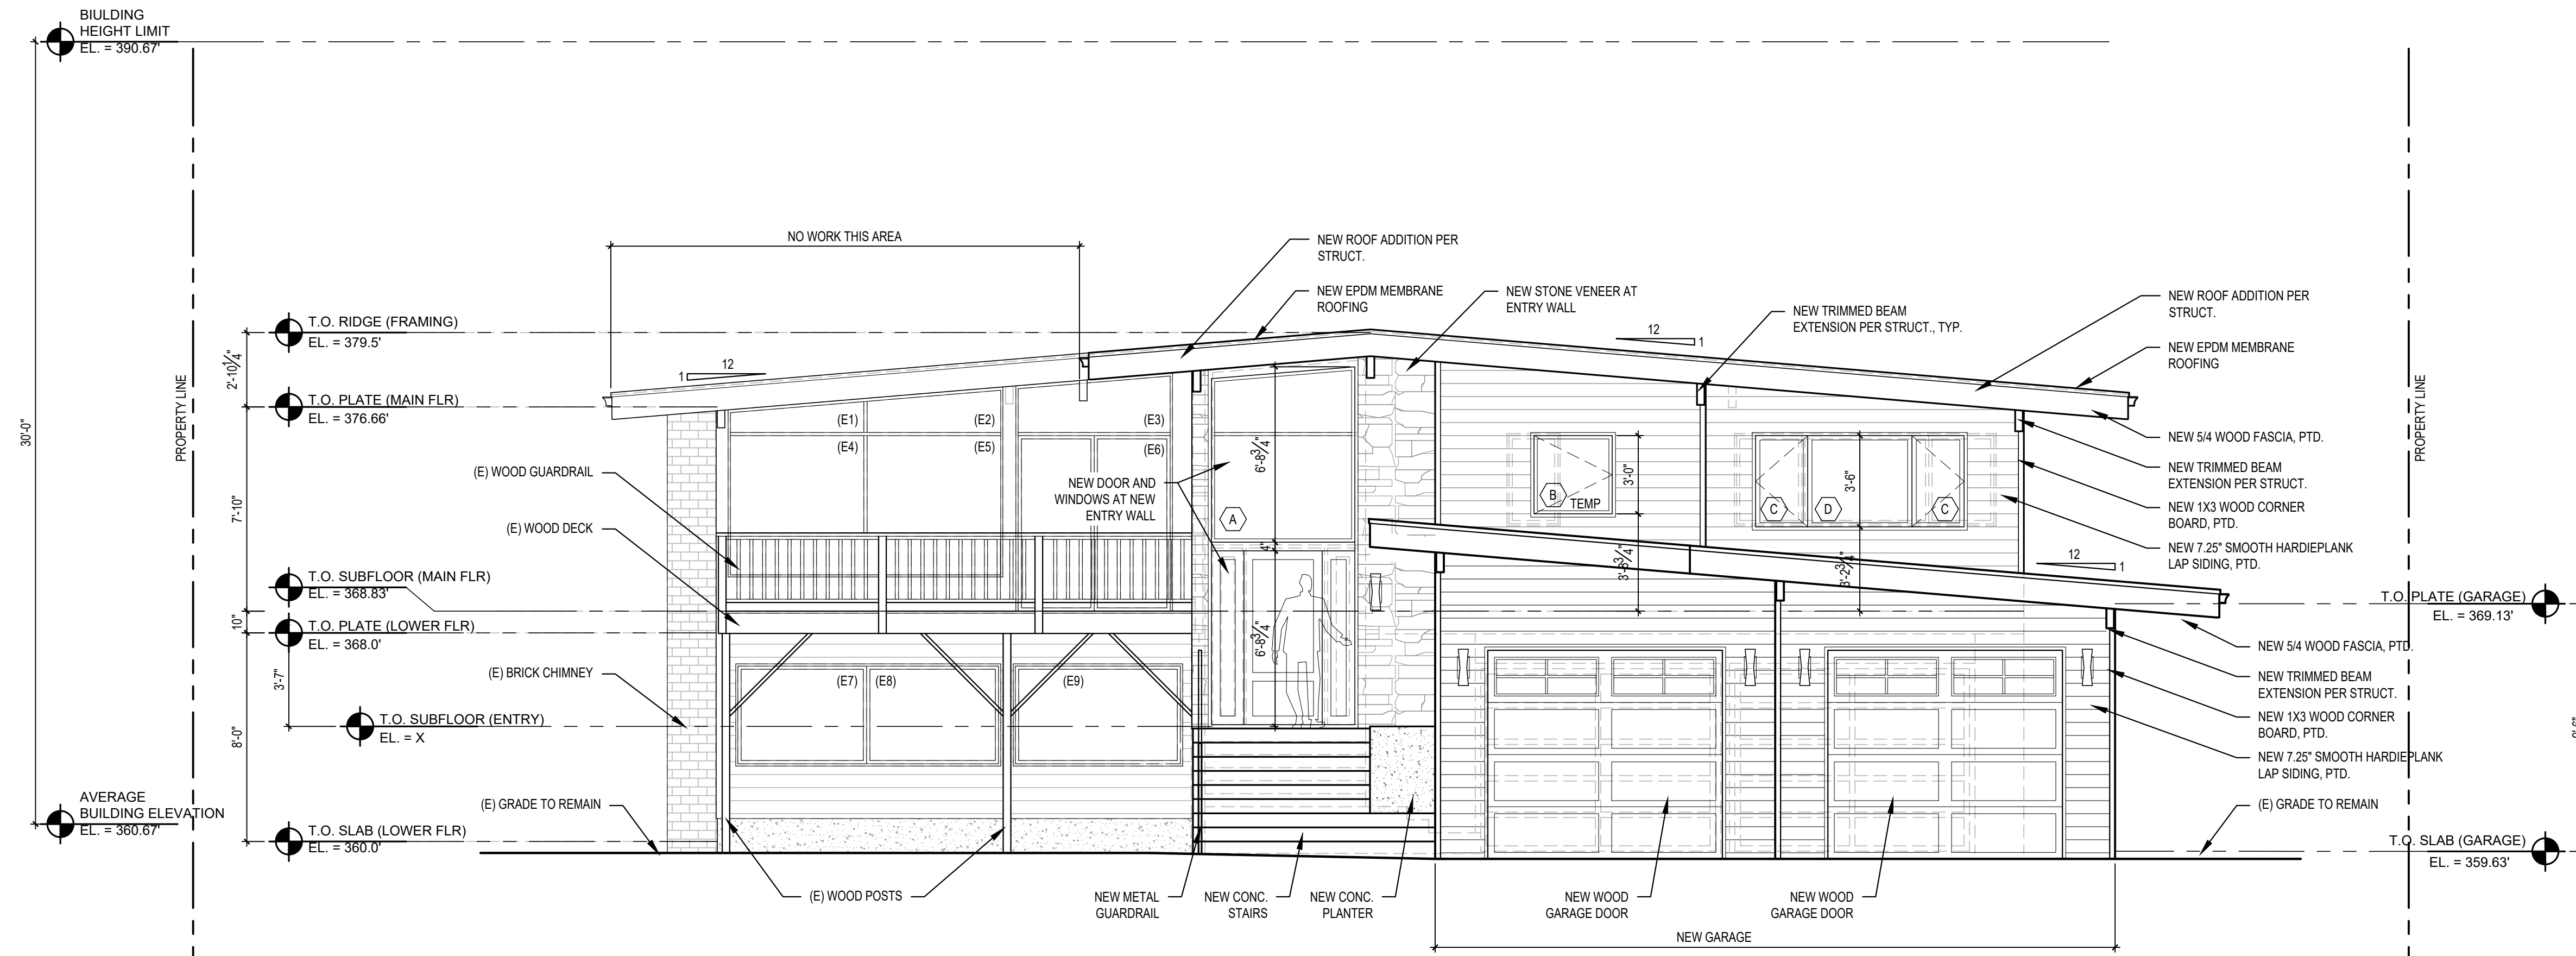


② EAST ELEVATION

SCALE: 1/4" = 1'-0"


SCALE: IF SHEET IS LESS THAN 24" x 36", IT IS A REDUCED PRINT, REDUCE SCALE ACCORDINGLY

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③ SOUTH ELEVATION
SCALE: 1/4" = 1'-0"

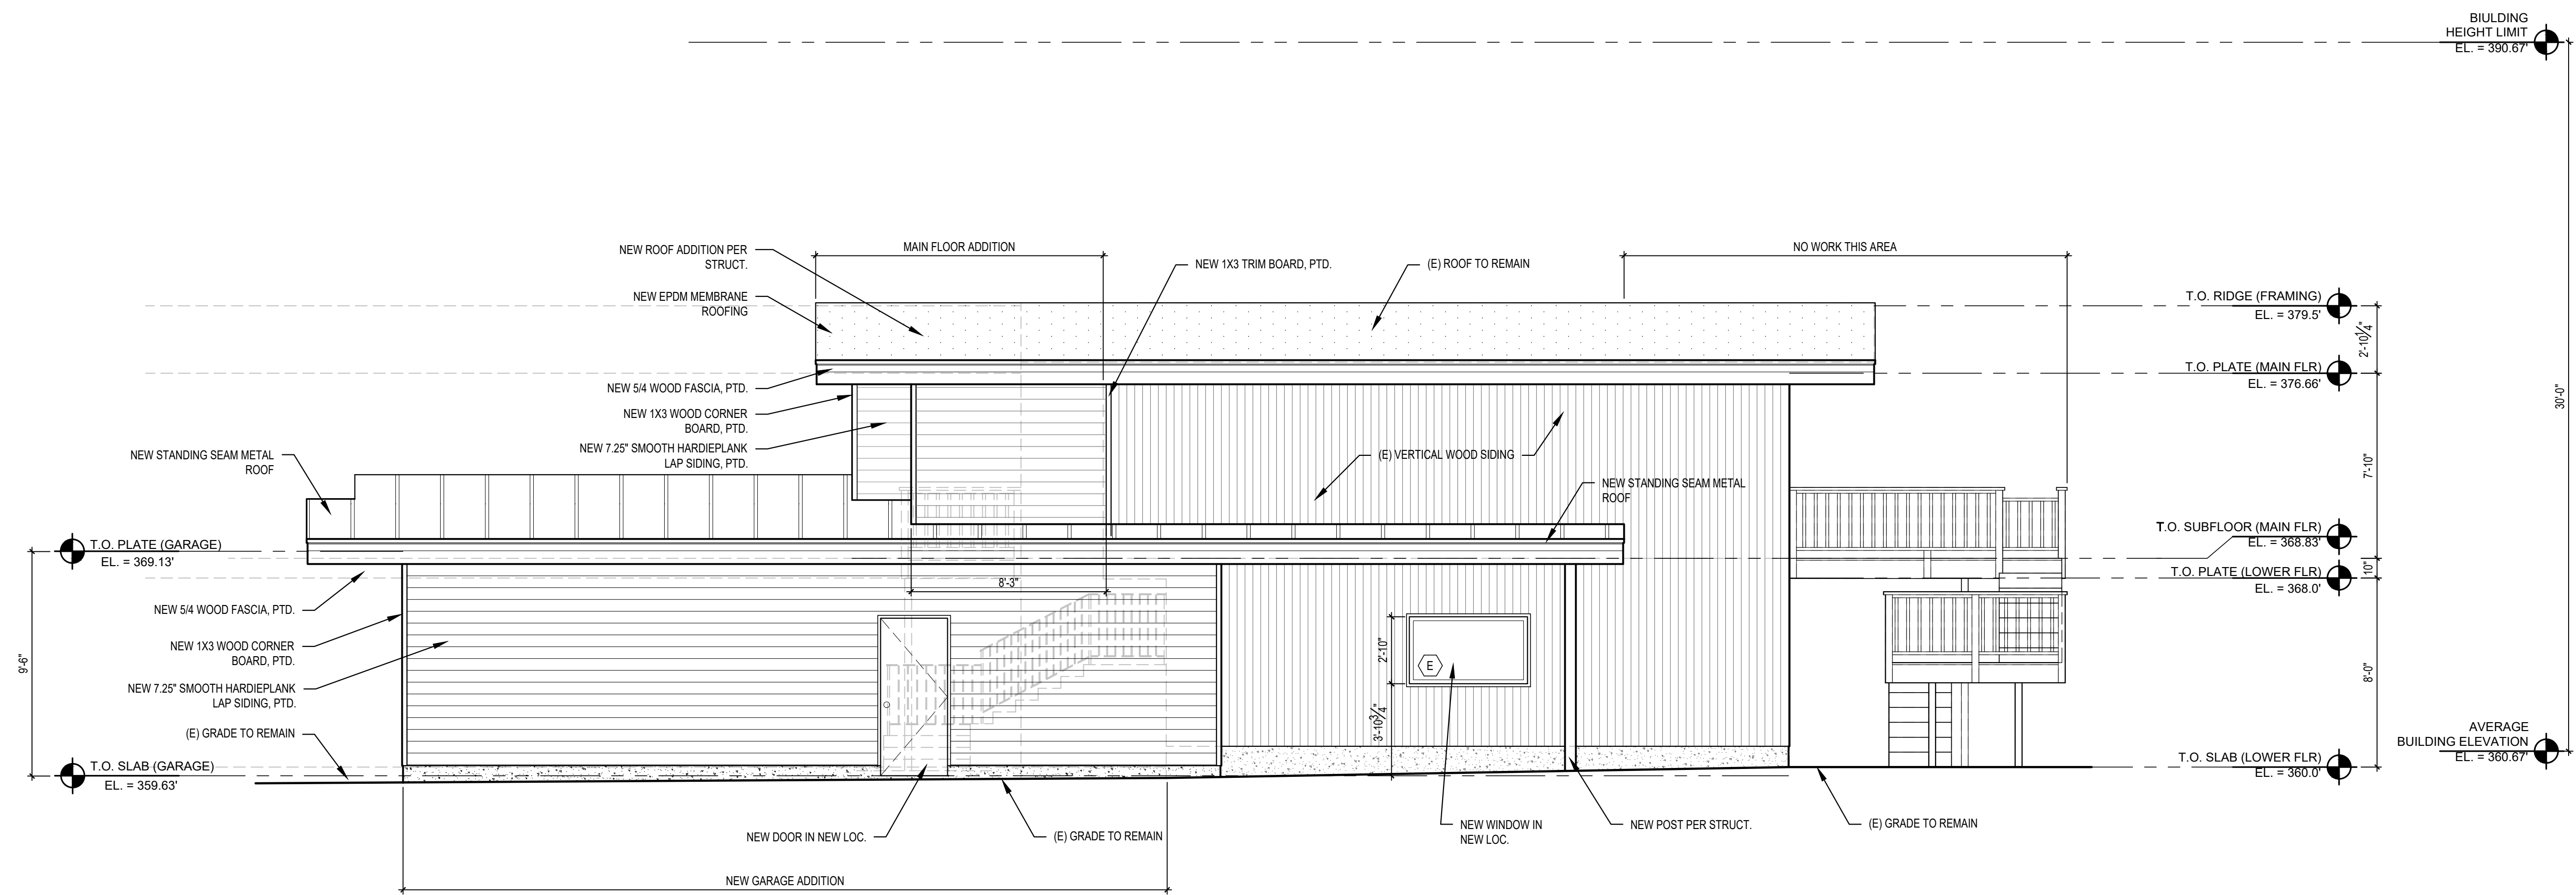


④ NORTH ELEVATION
SCALE: 1/4" = 1'-0"


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PERMIT SET 05/18/20
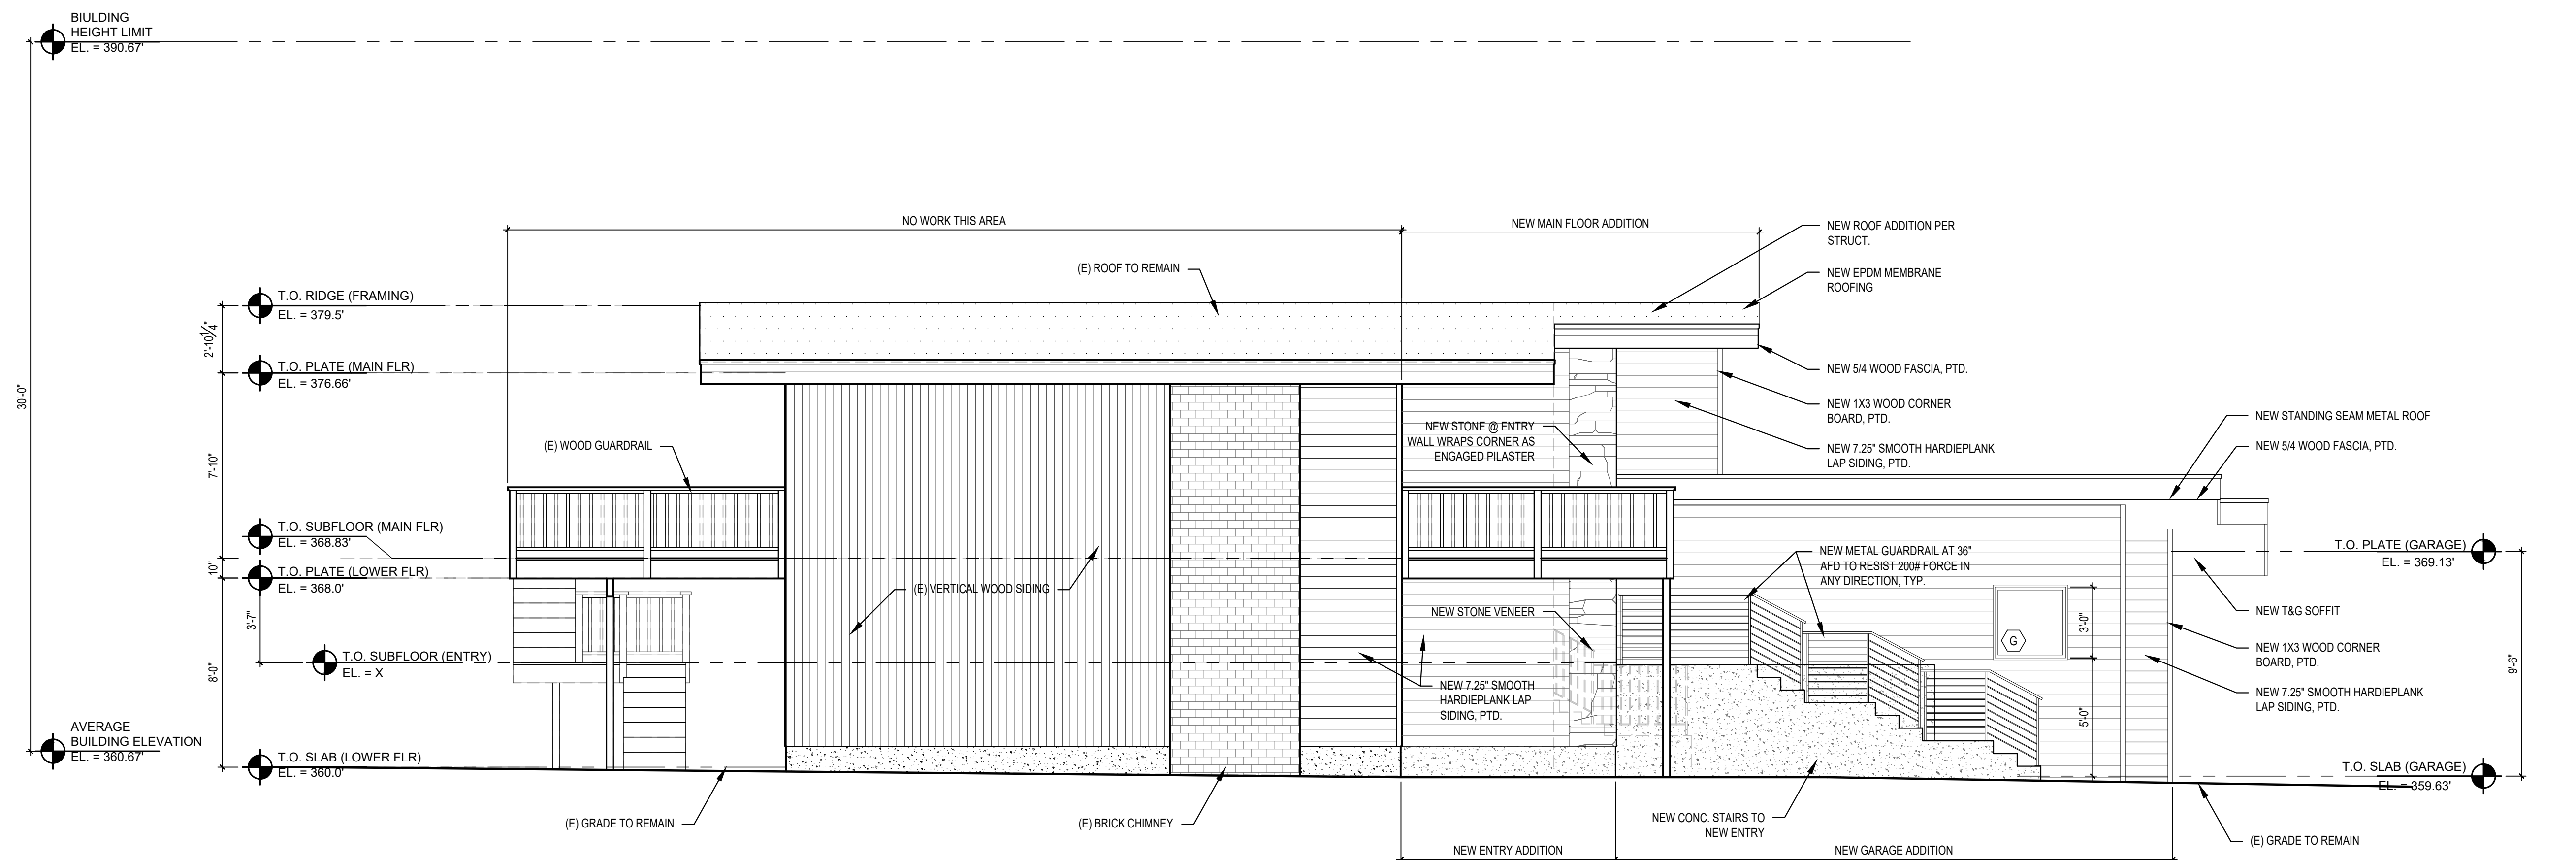
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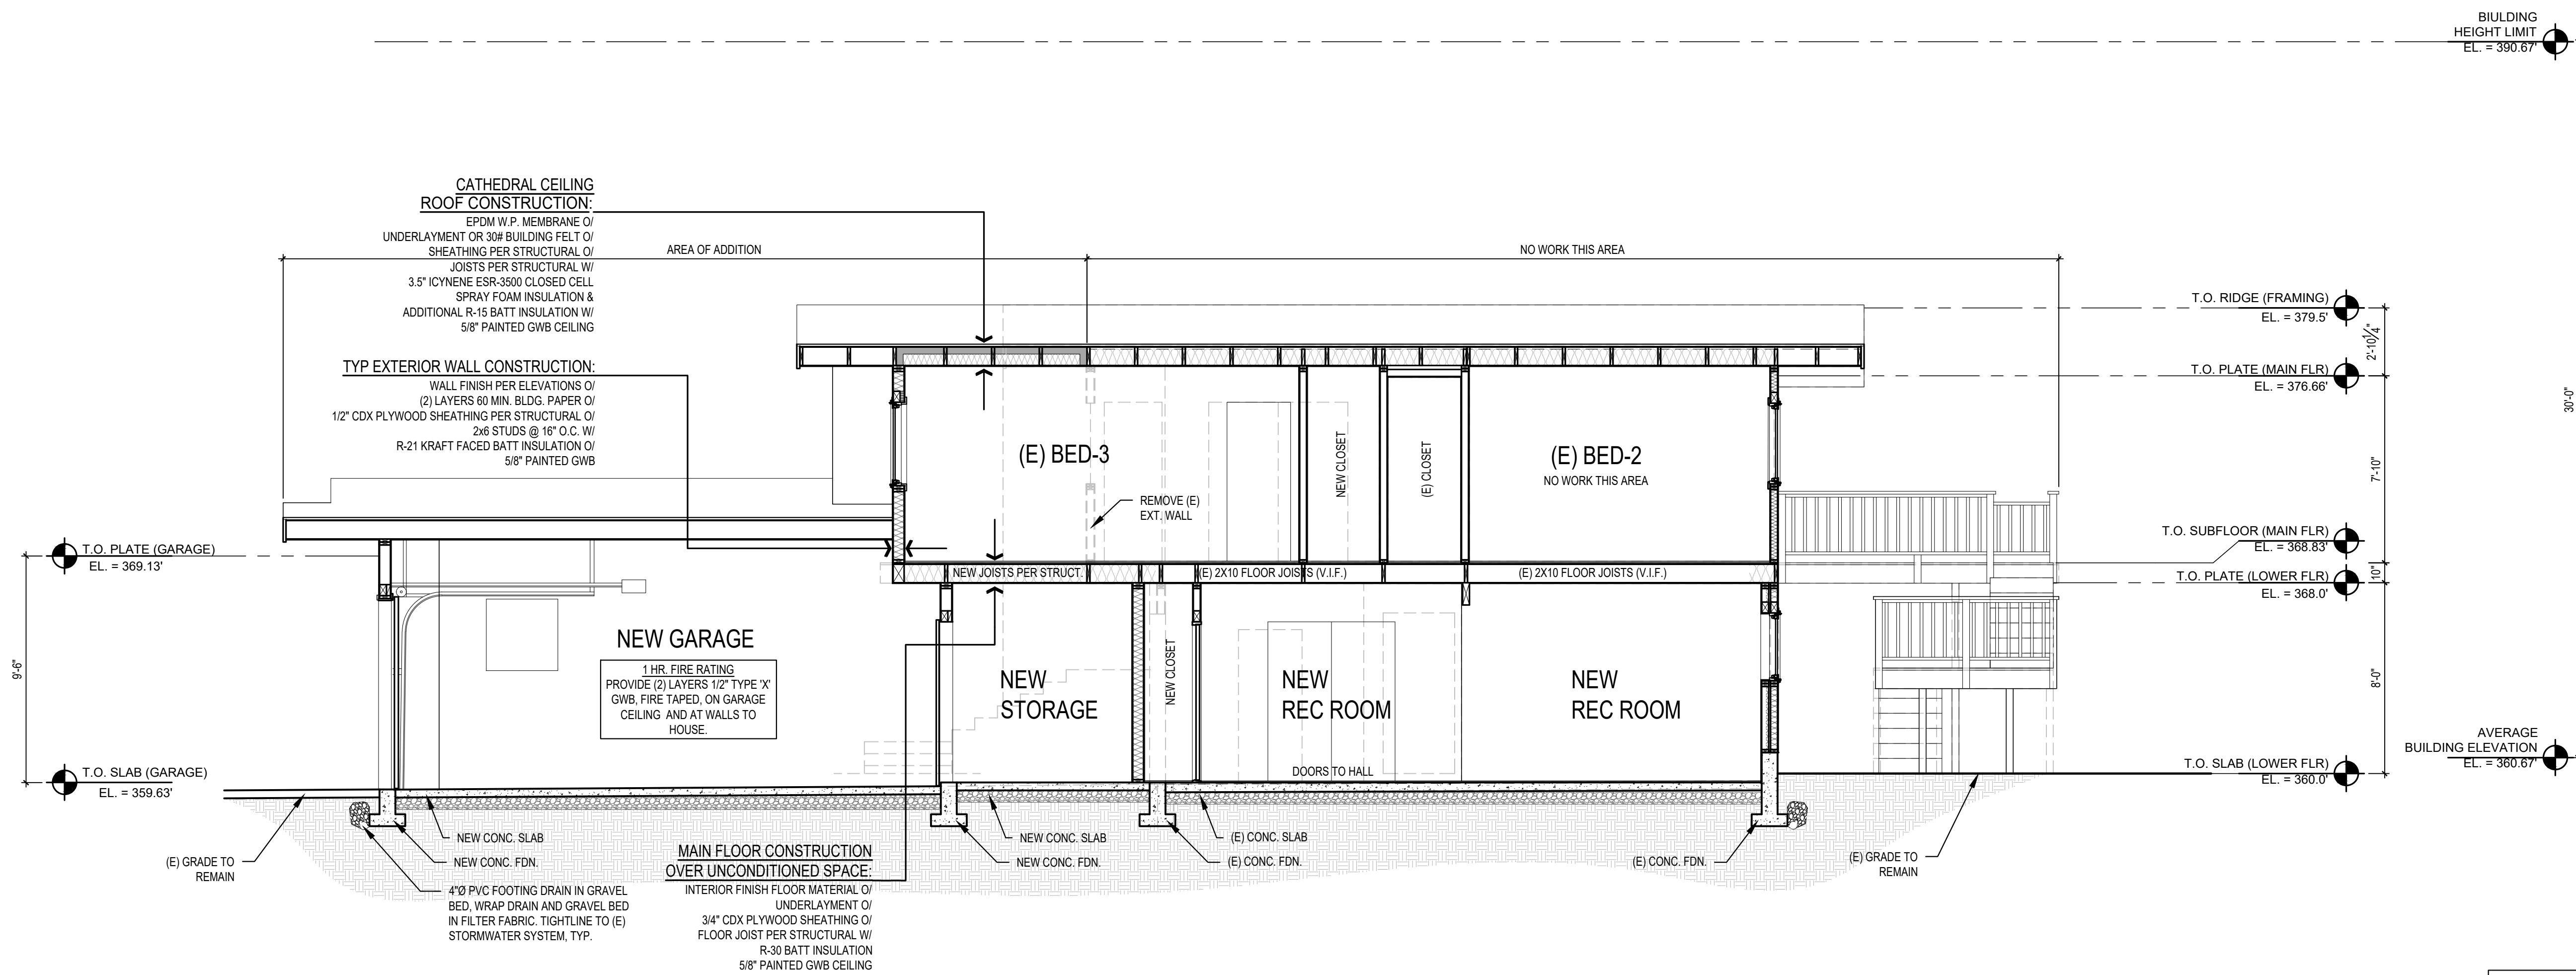
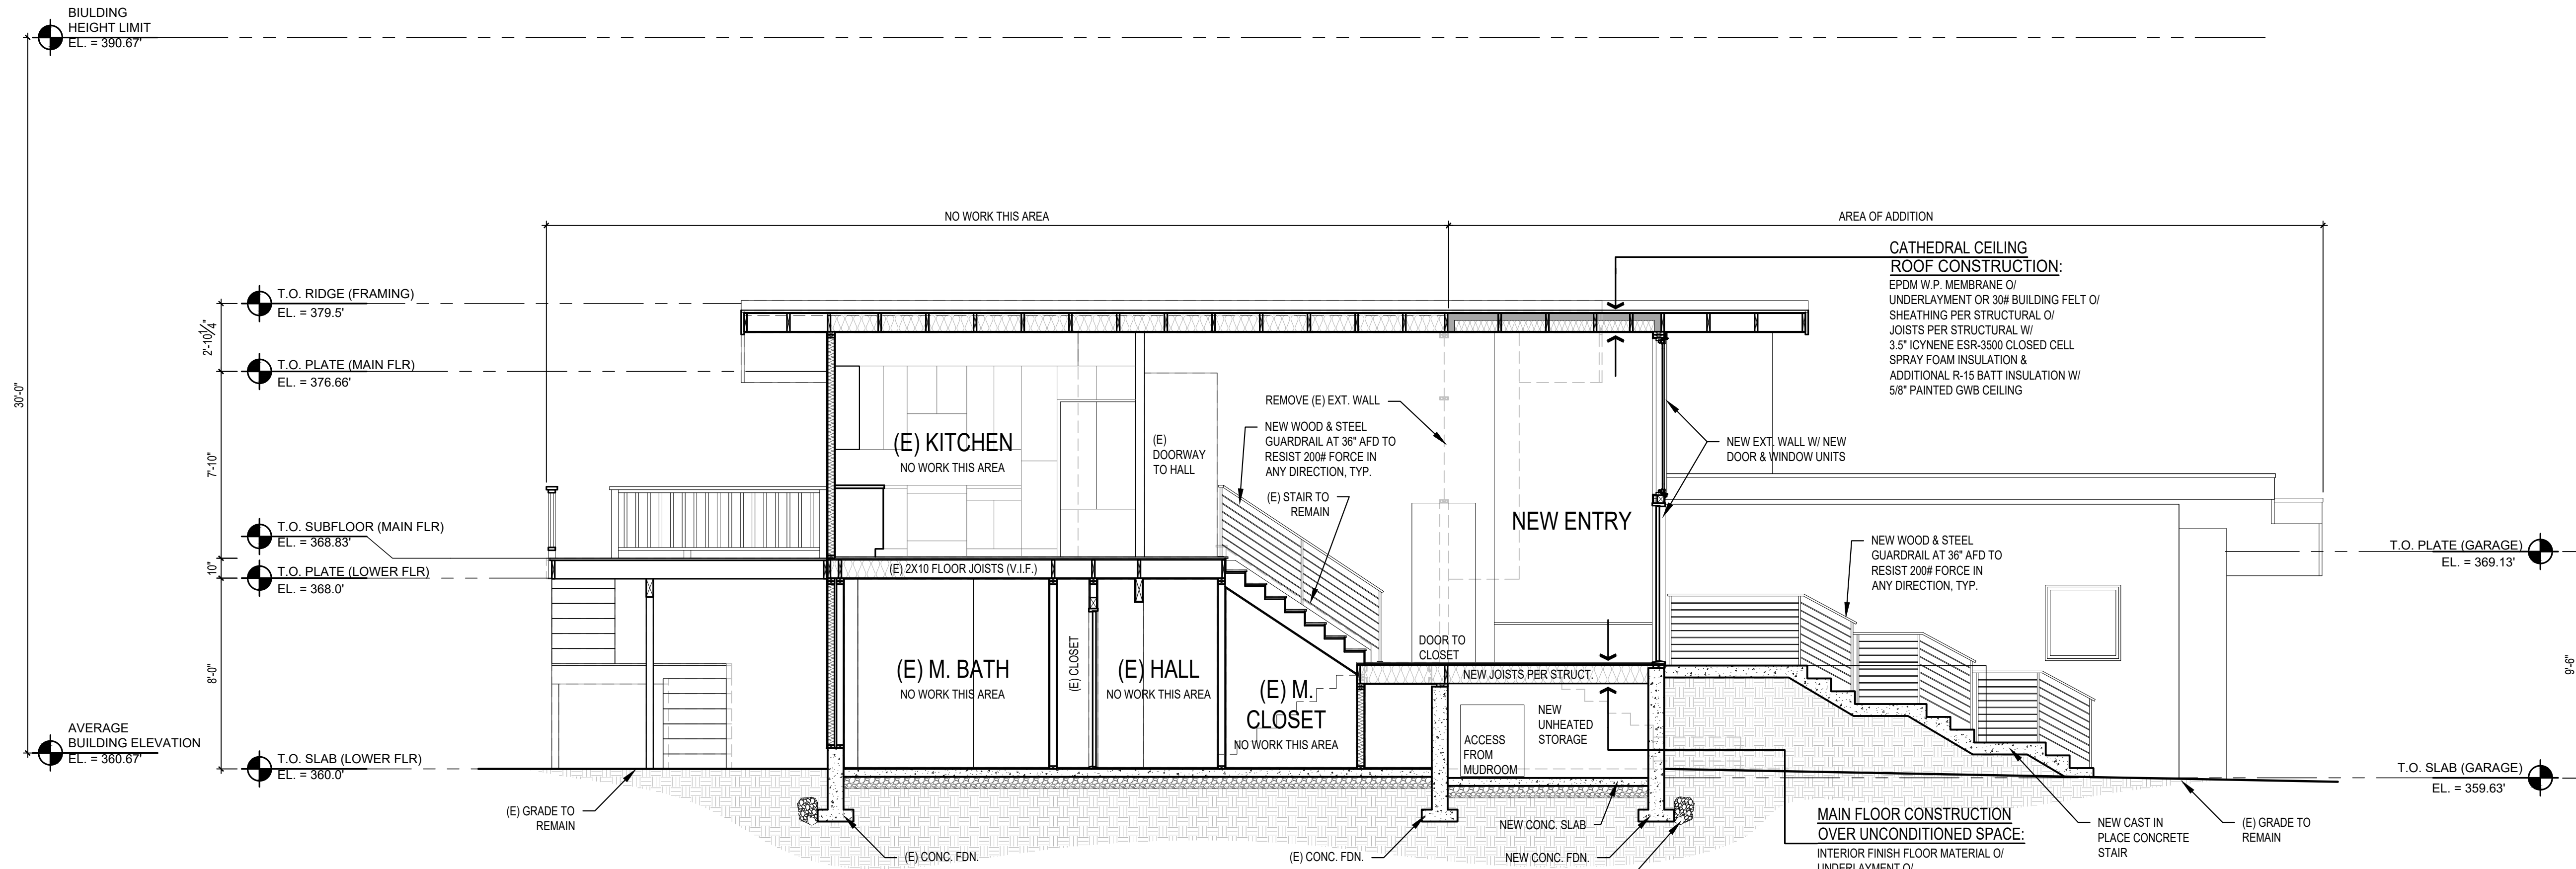
1 BUILDING SECTION
SCALE: 1/4" = 1'-0"

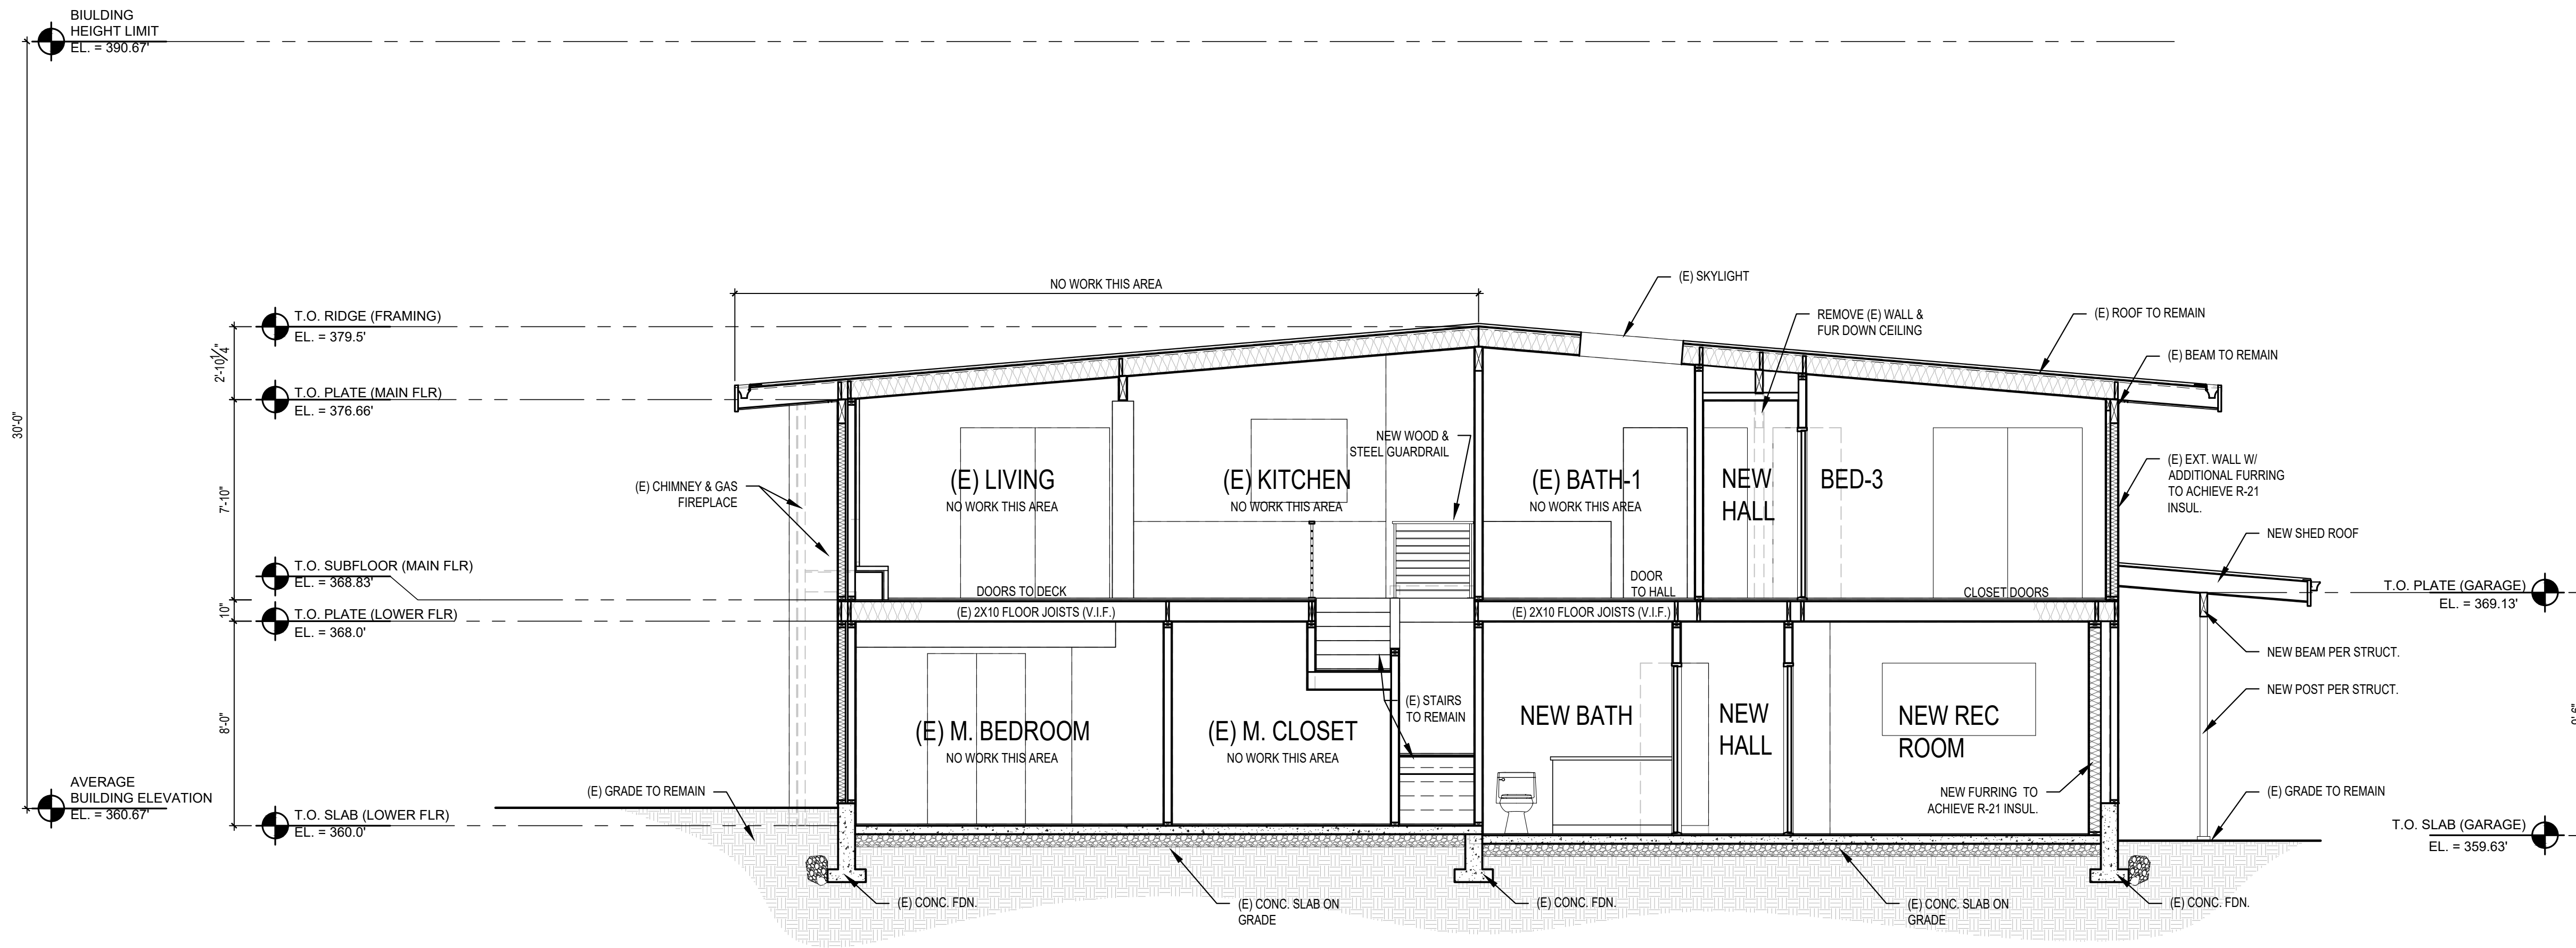

2 BUILDING SECTION
SCALE: 1/4" = 1'-0"

SCALE: IF SHEET IS LESS THAN 24" x 36", IT IS A REDUCED PRINT, REDUCE SCALE ACCORDINGLY

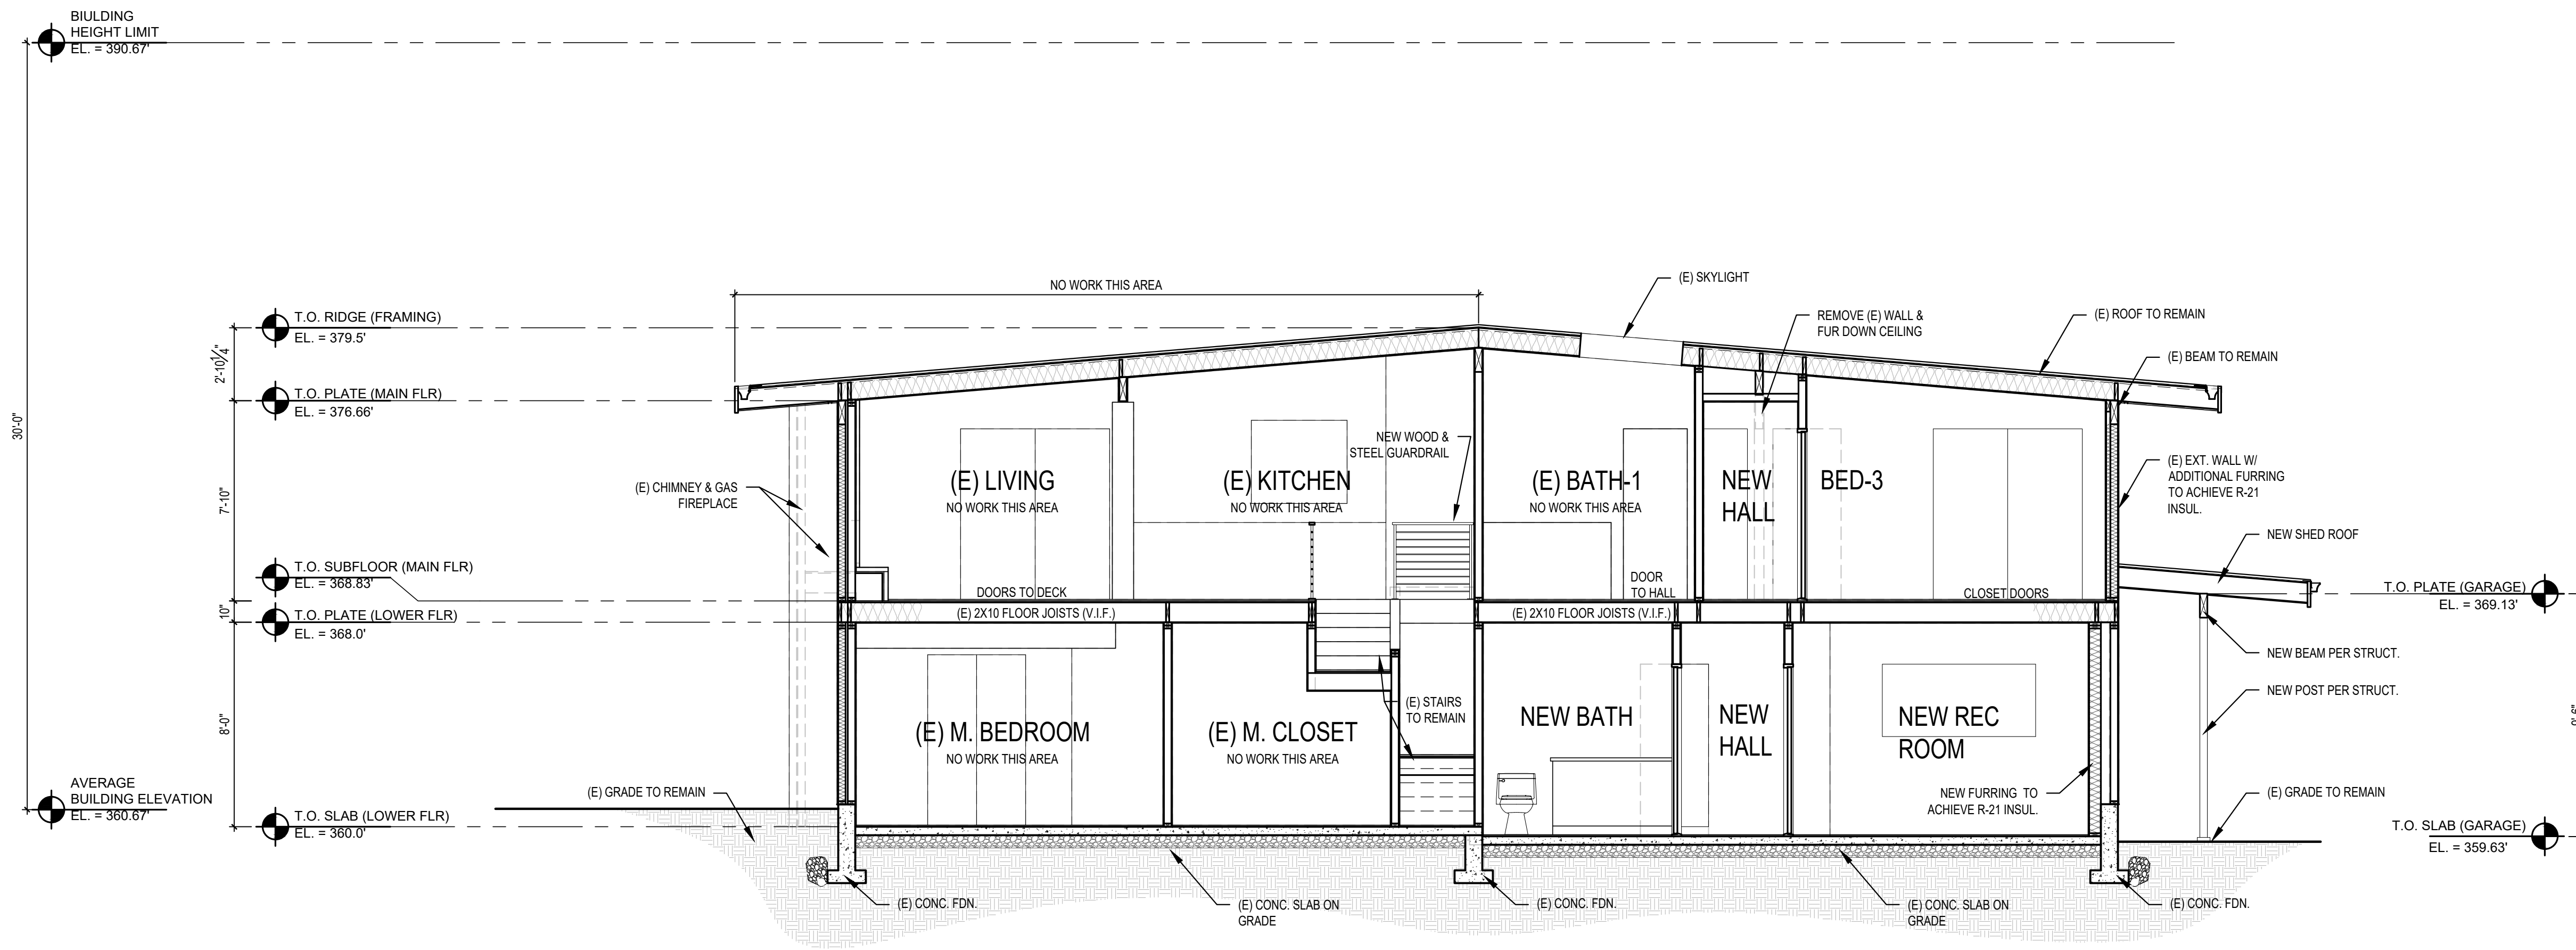
PERMIT SET 05/18/20
PLOT DATE: 5/18/2020 FILE NAME:




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PERMIT SET 05/18/20

PLOT DATE: 5/18/2020 FILE NAME:

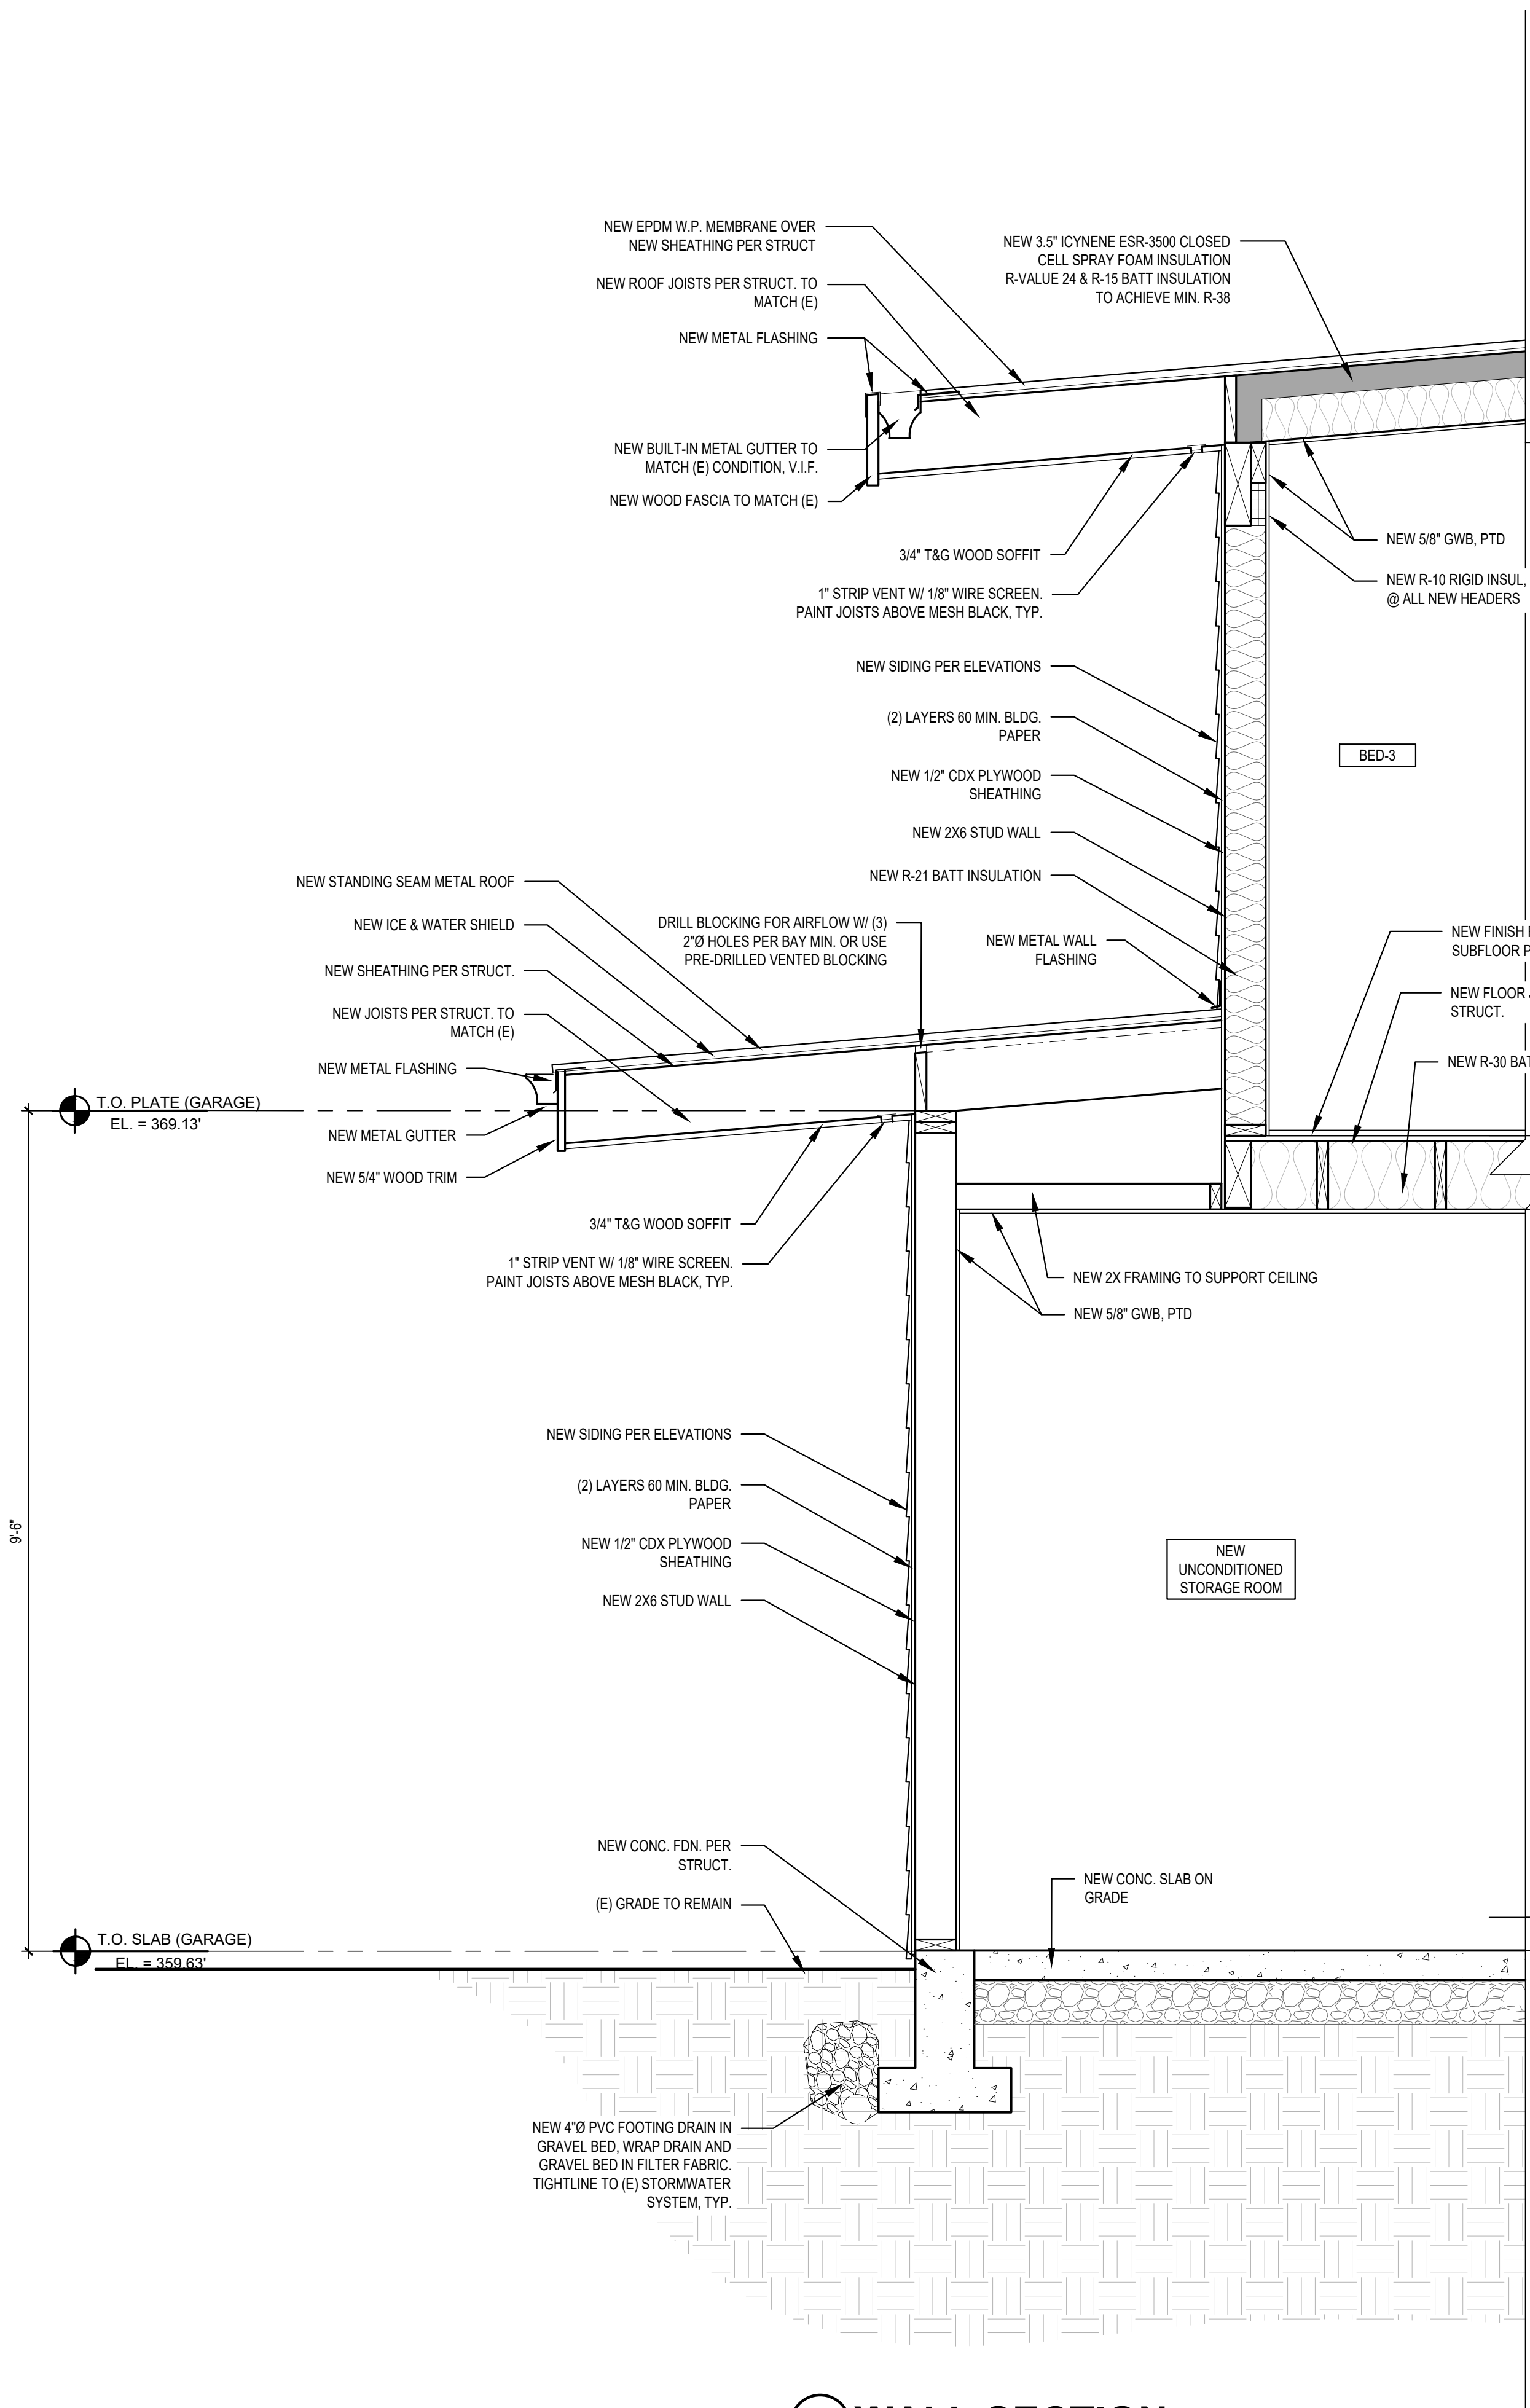


1 WALL SECTION
SCALE: 3/4" = 1'-0"

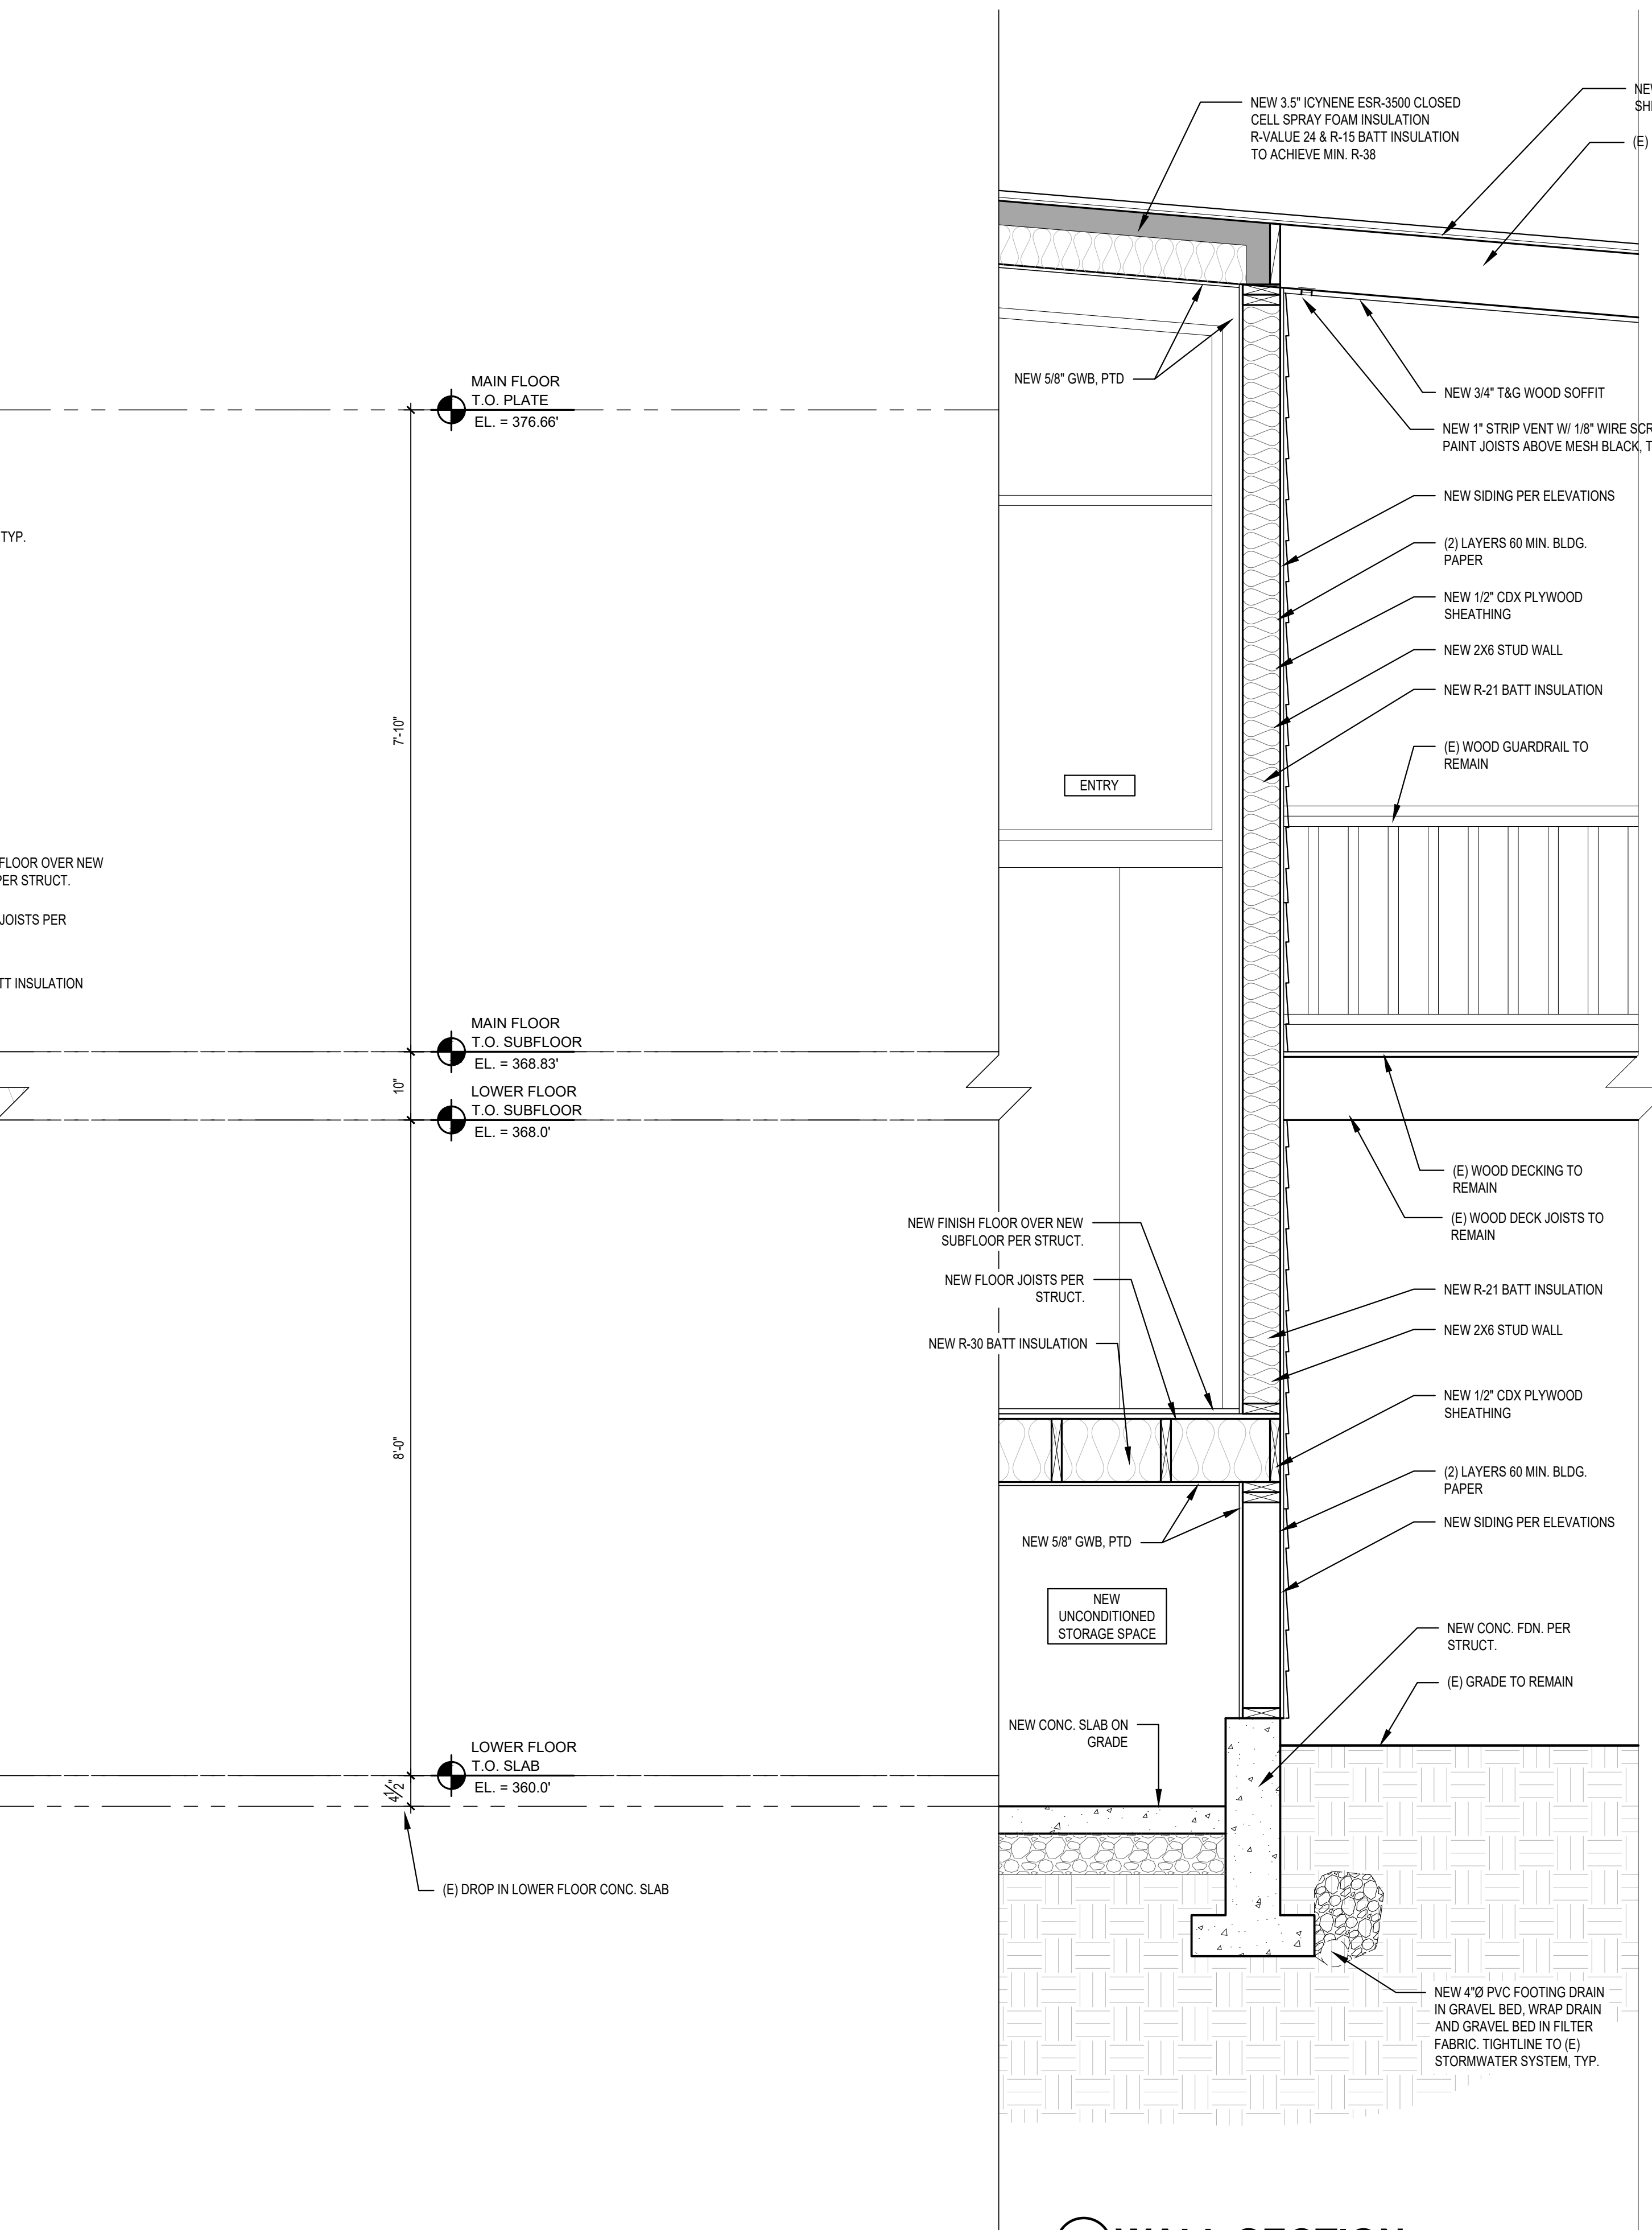


2 WALL SECTION
SCALE: 3/4" = 1'-0"

SCALE: IF SHEET IS LESS THAN 24" x 36", IT IS A REDUCED PRINT, REDUCE SCALE ACCORDINGLY

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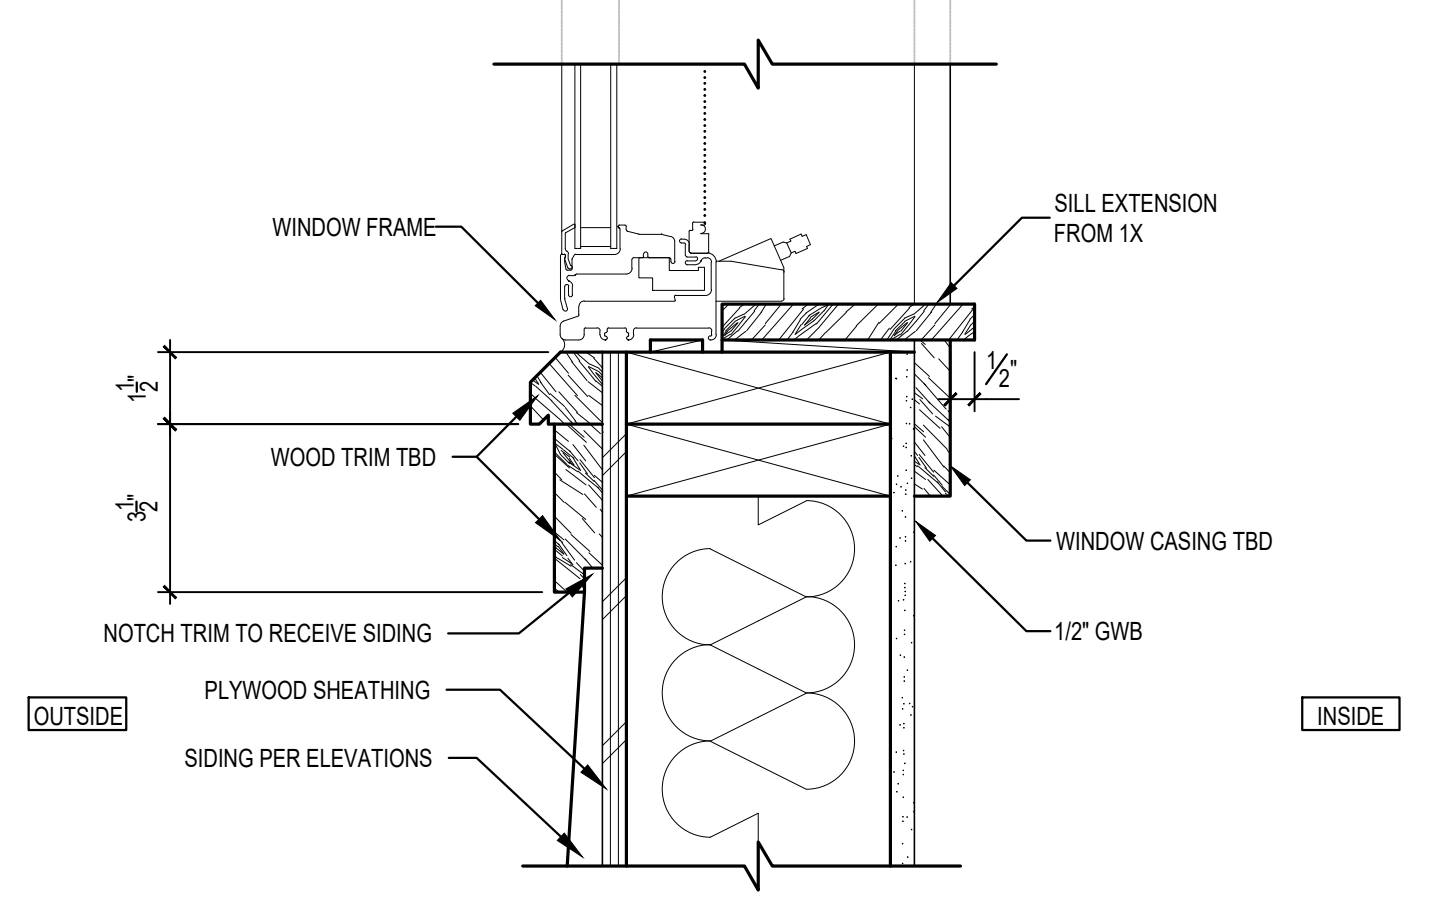
1 TYPICAL WINDOW HEAD DETAIL
SCALE: 3" = 1'-0" SIM. AT WINDOW JAMB

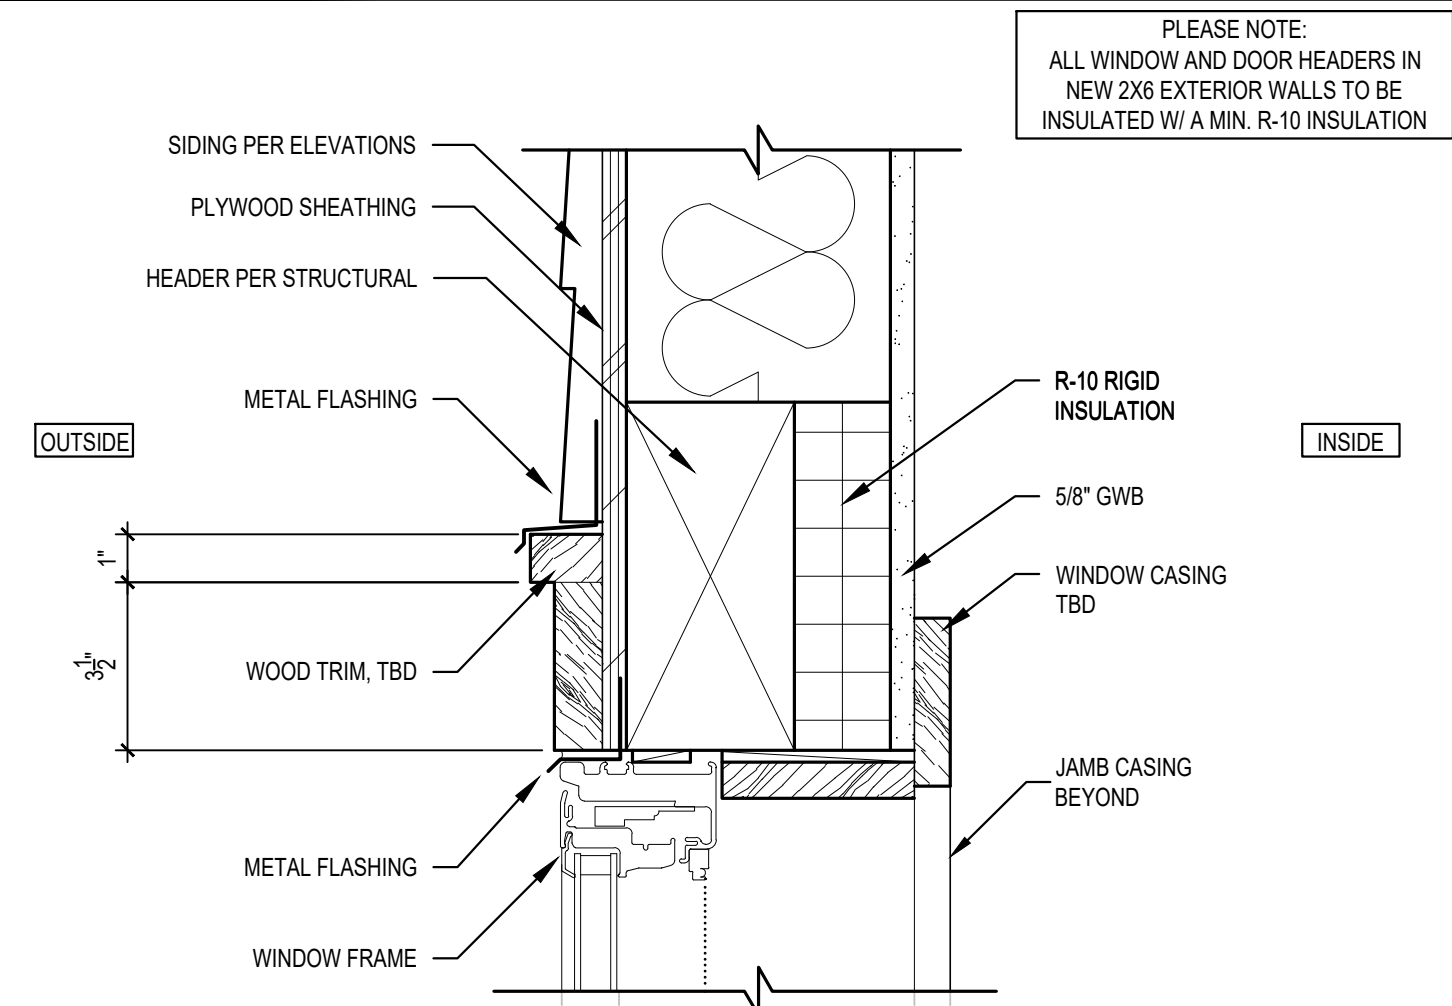


2 GUARDRAIL PLATE ATTACHMENT
SCALE: 3" = 1'-0" SIM. AT SIDE-MOUNTED

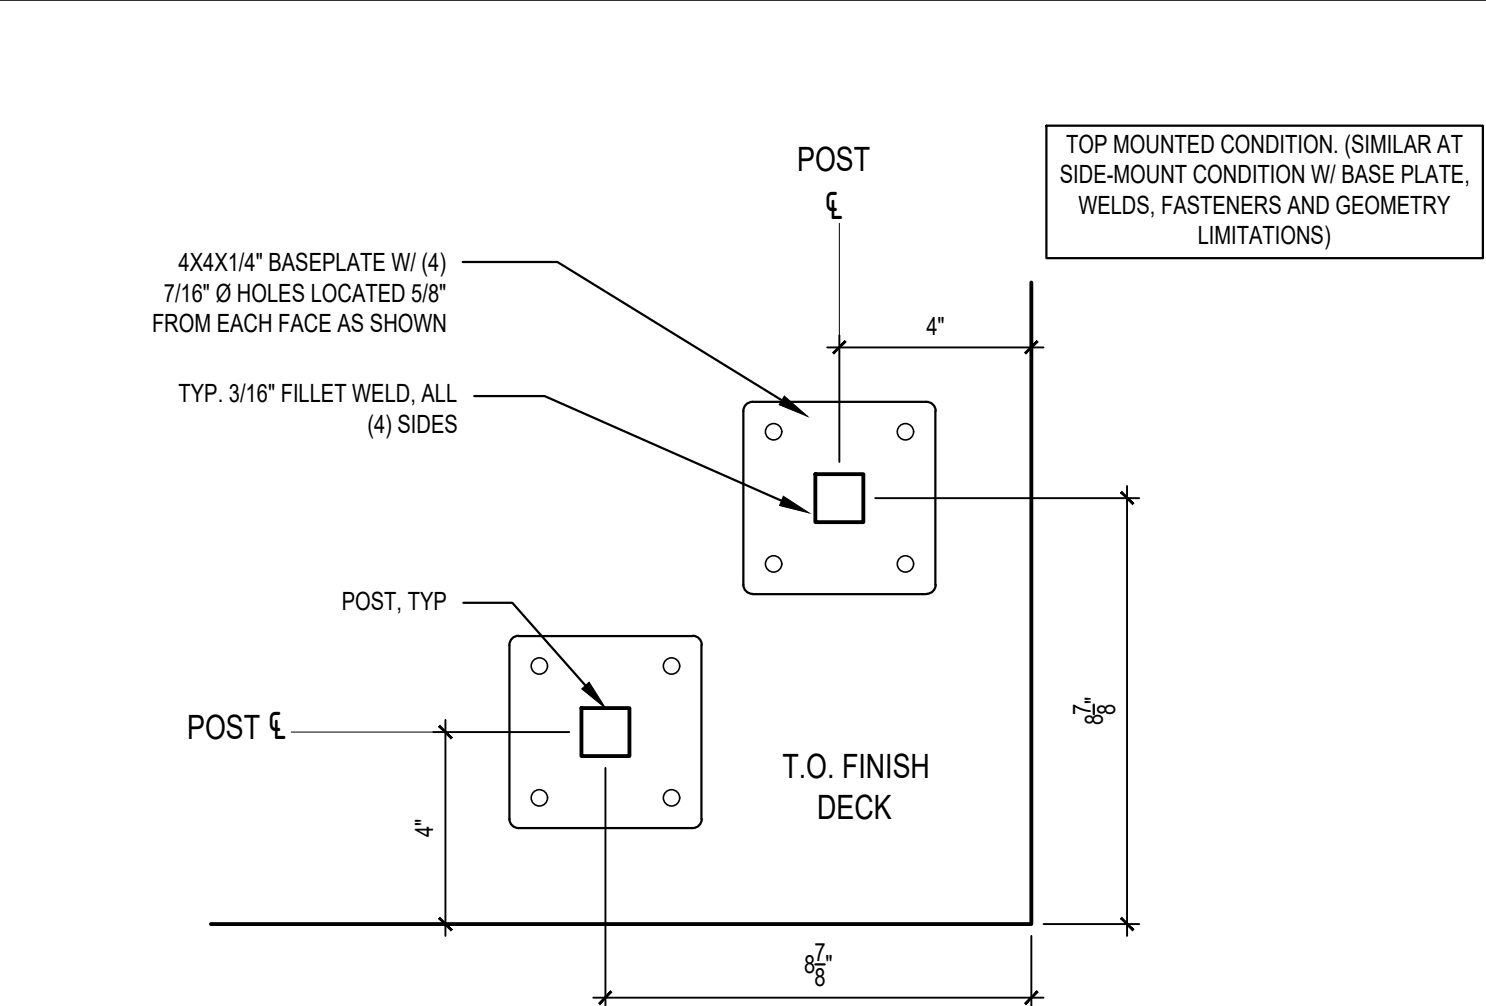3 NOT USED
SCALE: 1-1/2" = 1'-0"

4 NOT USED
SCALE: 1-1/2" = 1'-0"




5 TYPICAL WINDOW SILL DETAIL
SCALE: 3" = 1'-0"

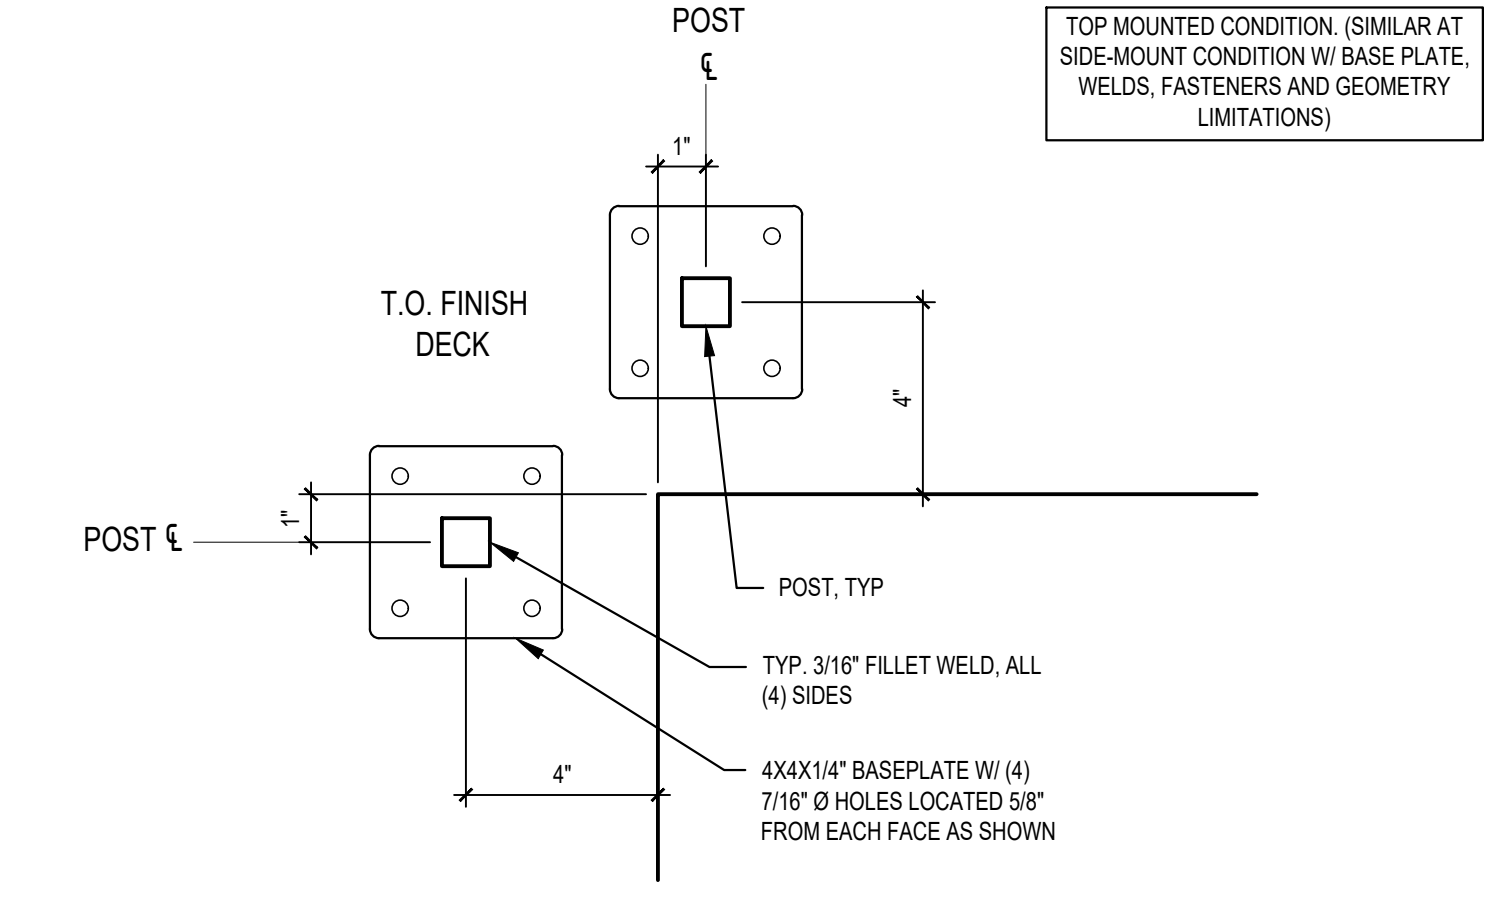


6 GUARDRAIL PLATE ATTACHMENT
SCALE: 3" = 1'-0" SIM. AT SIDE-MOUNTED

7 NOT USED
SCALE: 1-1/2" = 1'-0"

8 NOT USED
SCALE: 1-1/2" = 1'-0"

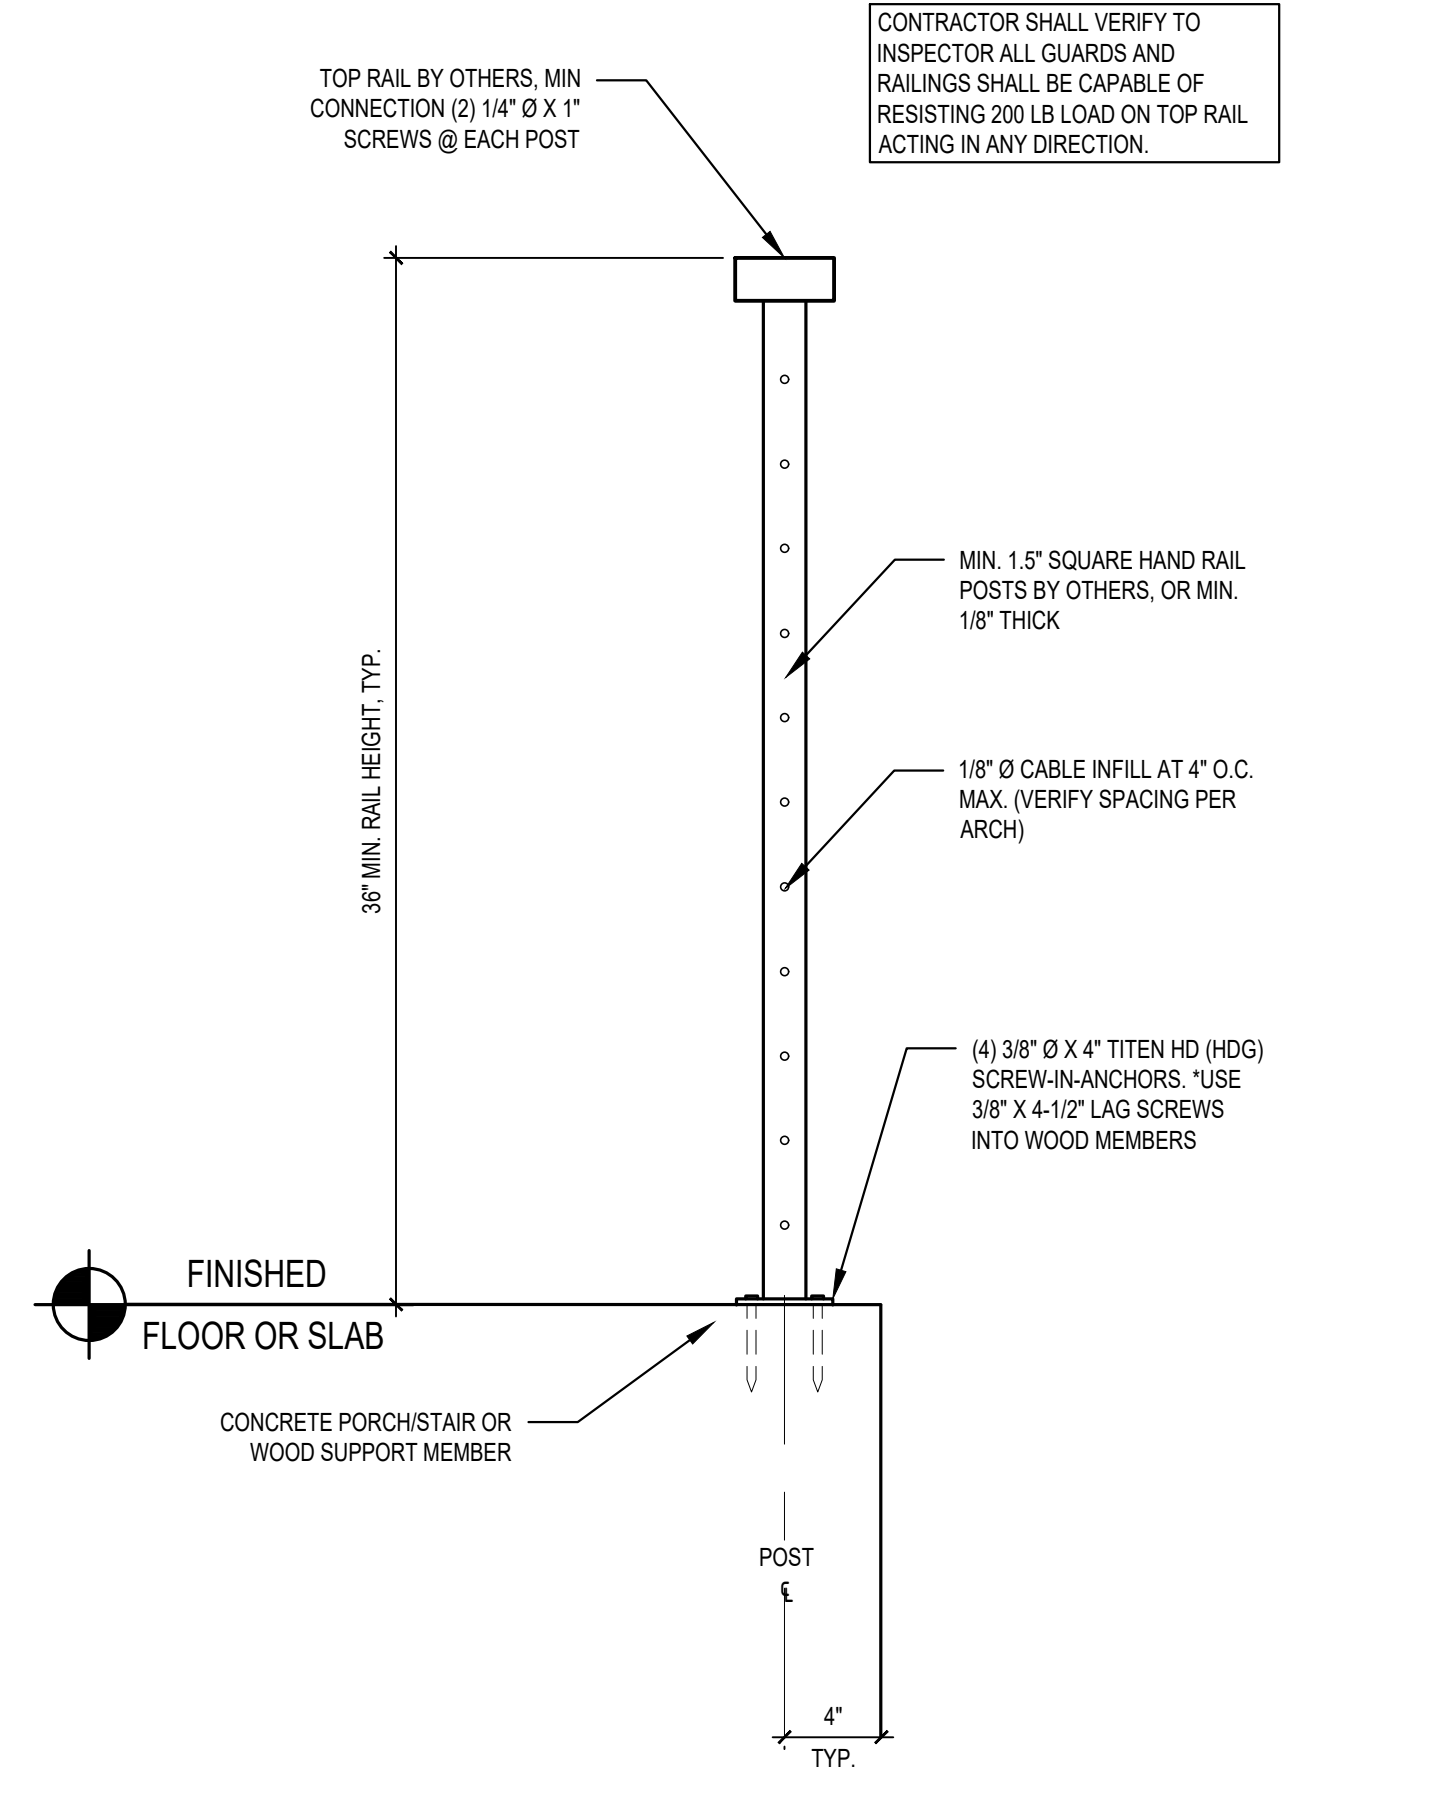

9 RAILING ATTACHMENT - TOP-MOUNTED
SCALE: 1-1/2" = 1'-0"

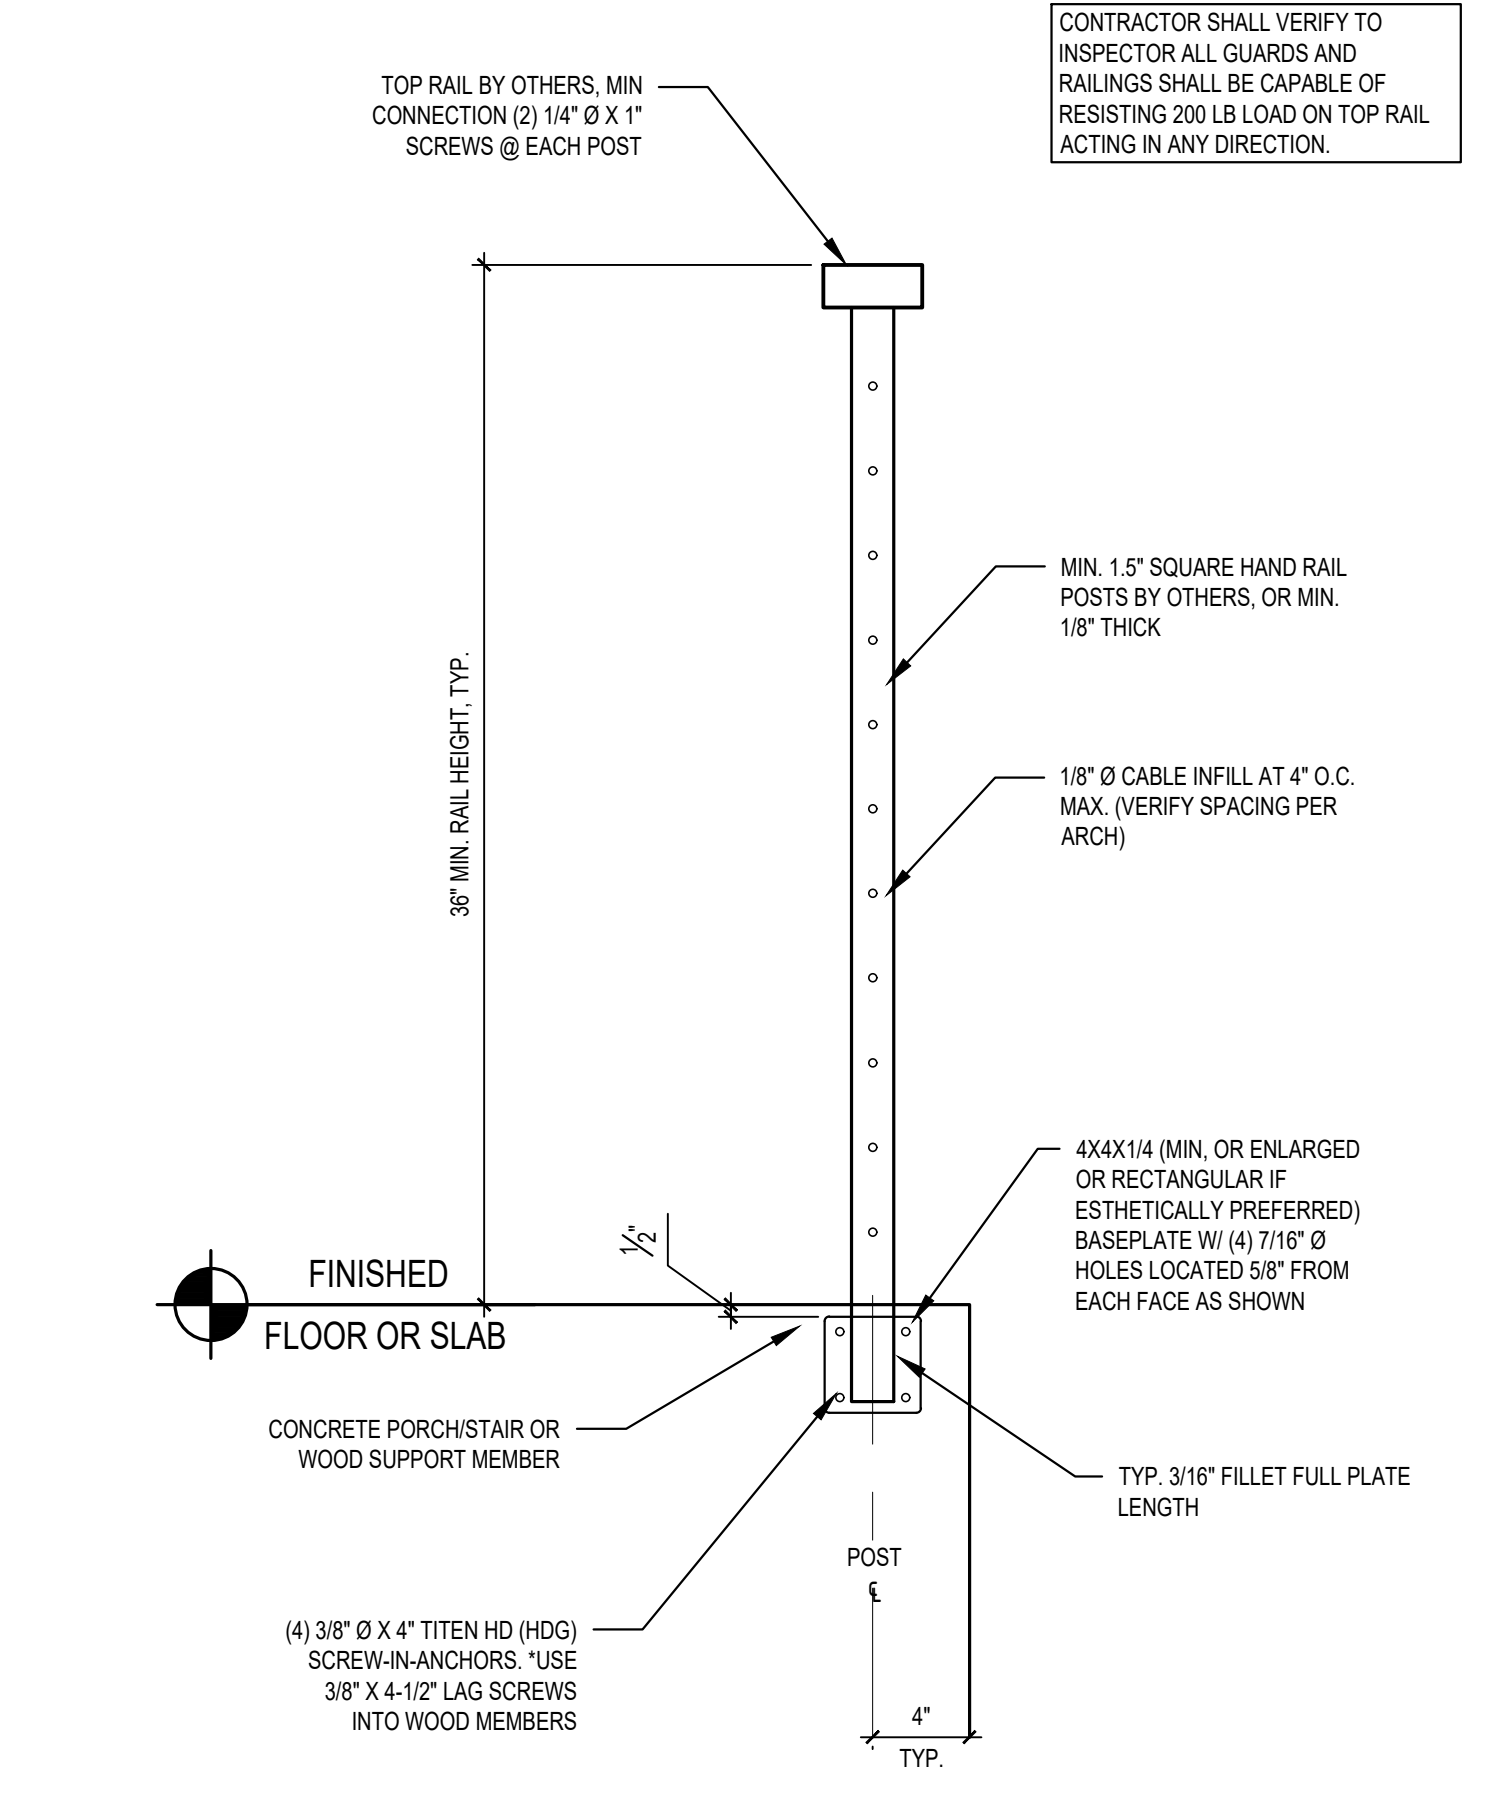


10 RAILING ATTACHMENT - SIDE-MOUNTED
SCALE: 1-1/2" = 1'-0"

11 NOT USED
SCALE: 1-1/2" = 1'-0"

12 NOT USED
SCALE: 1-1/2" = 1'-0"

13 NOT USED
SCALE: 1-1/2" = 1'-0"

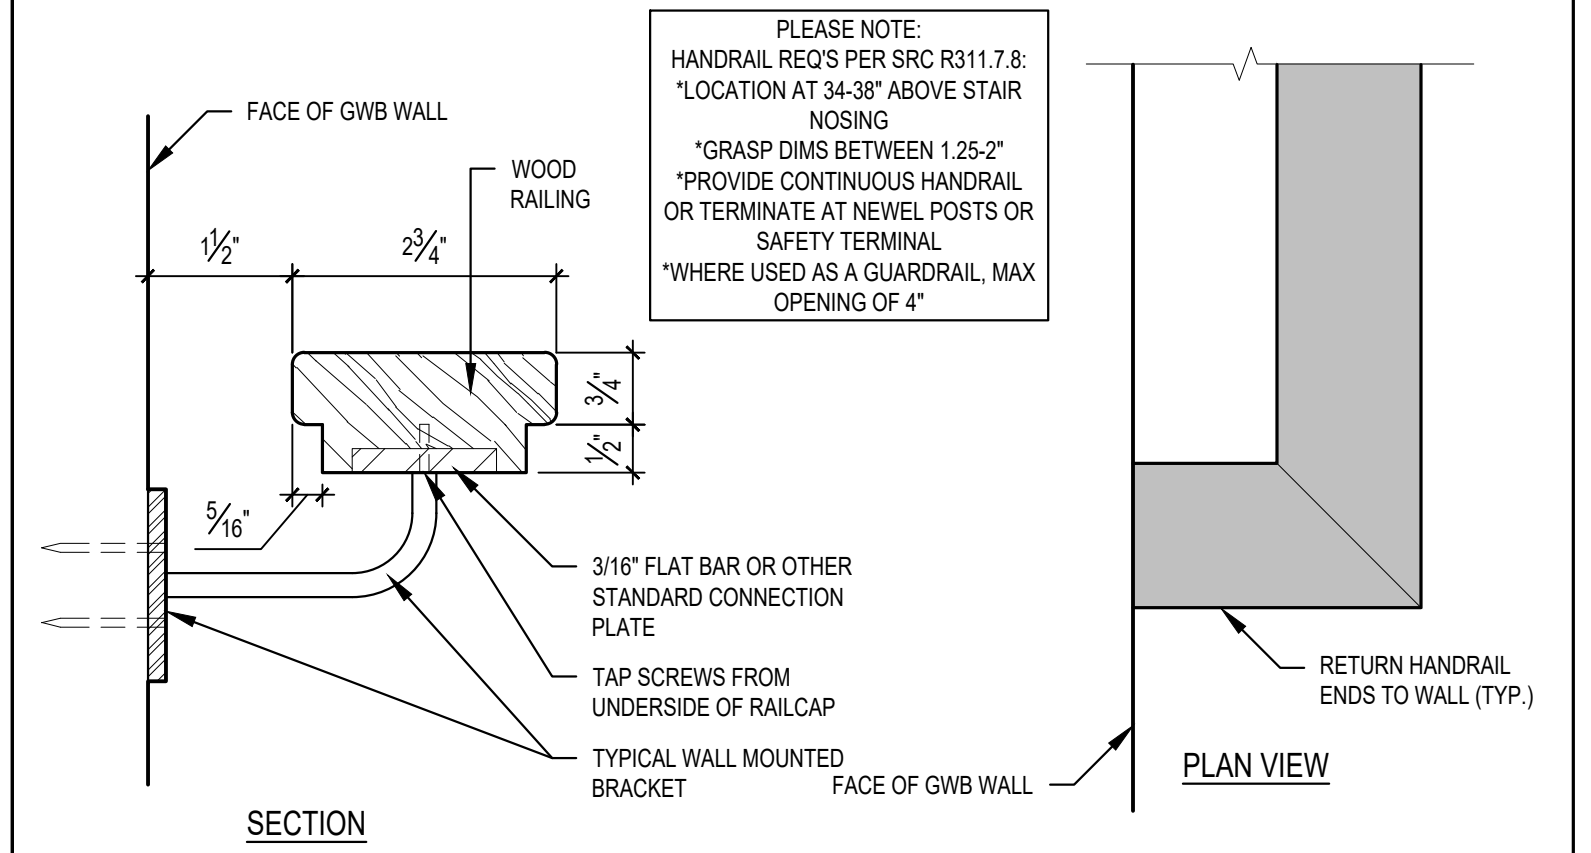

14 HANDRAIL DETAIL
SCALE: 6" = 1'-0"

SCALE: IF SHEET IS LESS THAN 24" x 36", IT IS
A REDUCED PRINT, REDUCE SCALE ACCORDINGLY


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 Shoreline, WA 98133
 (206) 779-6856

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 MERCER ISLAND, WA 98040

FOUNDATION AND LOWER FLOOR PLAN



LEGEND

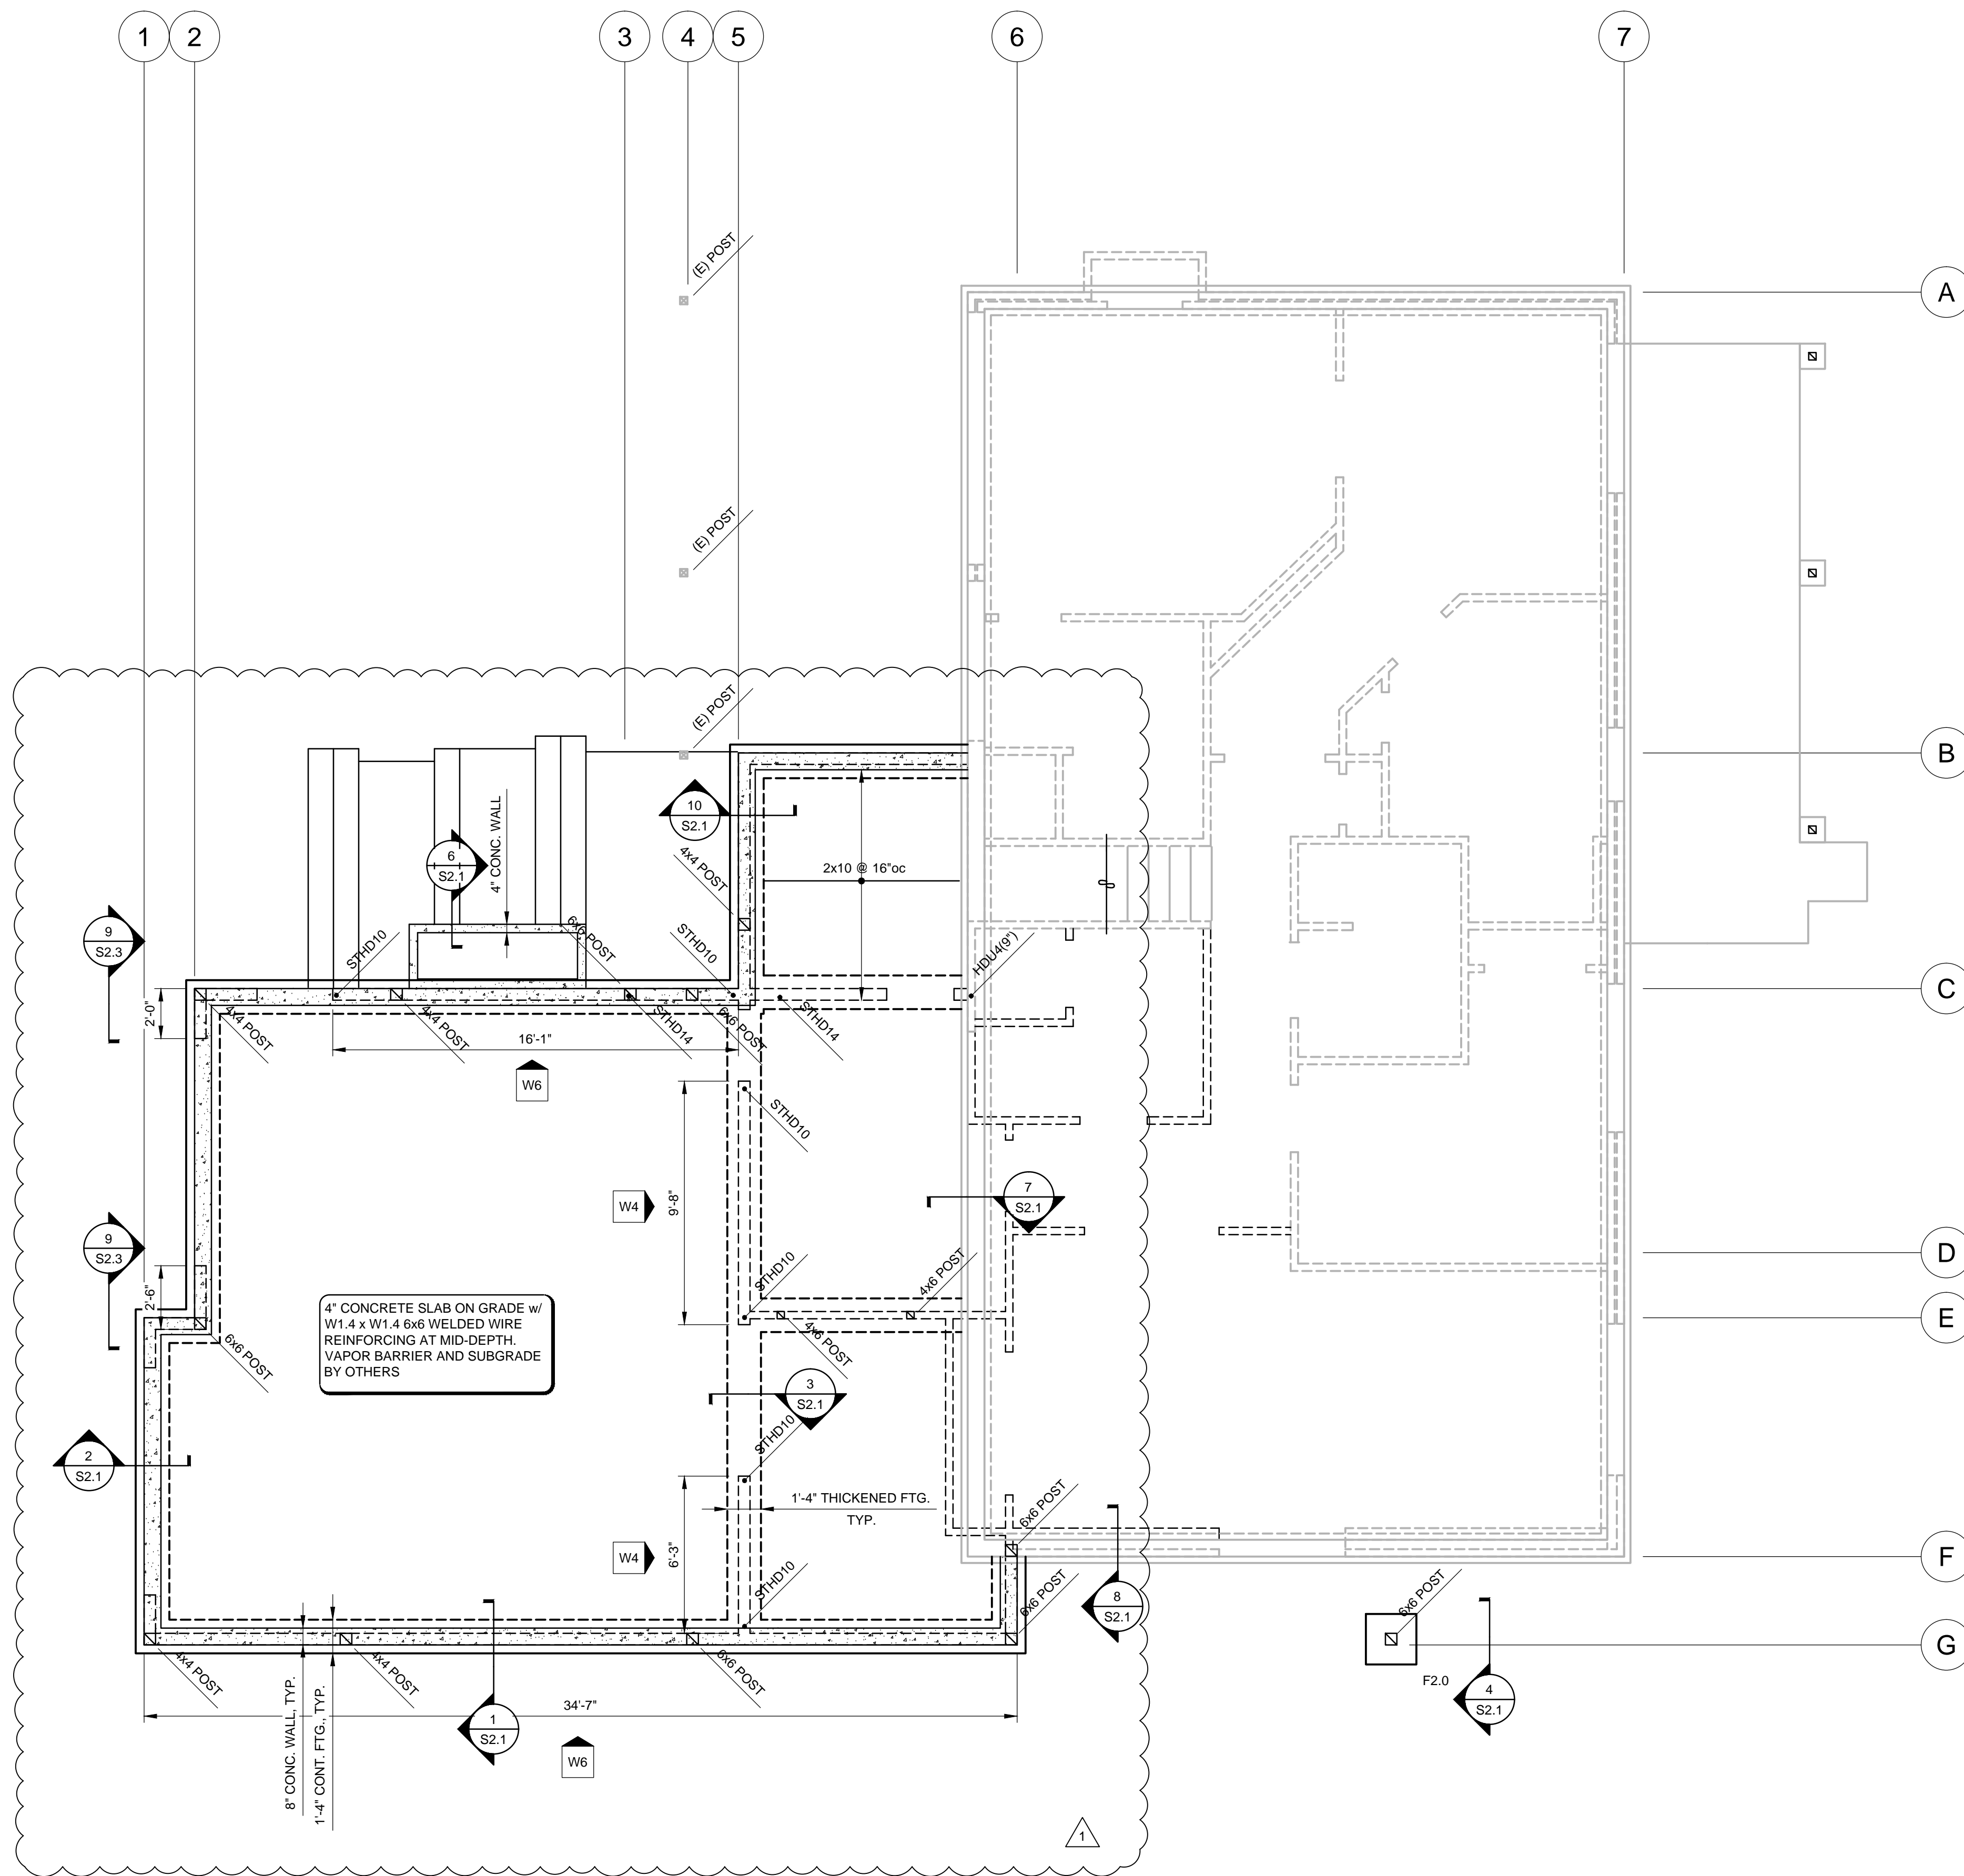- CONCRETE WALL
- INTERIOR STUD WALL BELOW;
EXTERIOR BEARING STUD WALL BELOW
- STUD WALL ABOVE
- COLUMN CONTINUOUS
- COLUMN BELOW FRAMING LEVEL
- COLUMN ABOVE FRAMING LEVEL
- SHEAR WALL HOLDDOWN AT FRAMING LEVEL
- SHEAR WALL ABOVE FRAMING LEVEL
- (2) SIMPSON CS16 x 24", U.N.O.

FOOTING SCHEDULE

MARK	SIZE	REINFORCEMENT
F1.5	1'-6" x 1'-6" x 10"	3- #4 EA. WAY BOT.
F2.0	2'-0" x 2'-0" x 10"	3- #4 EA. WAY BOT.
F2.5	2'-6" x 2'-6" x 11"	4- #4 EA. WAY BOT.
F3.0	3'-0" x 3'-0" x 11"	5- #5 EA. WAY BOT.
F3.5	3'-6" x 3'-6" x 11"	6- #5 EA. WAY BOT.
F4.0	4'-0" x 4'-0" x 12"	7- #5 EA. WAY BOT.

- NOTE:**
- SEE GENERAL NOTES FOR DESIGN BEARING CAPACITY
 - CENTER ALL FOOTING ON COLUMN OR WALL, TYP. U.N.O.
 - AT LOCATIONS WHERE FOOTINGS ARE SHOWN SHARING A COMMON BEARING AREA, CAST MONOLITHICALLY WITH INDIVIDUAL REINFORCING PER SCHEDULE AND OVERLAP AS REQUIRED.
 - FOOTING SCHEDULE IS PROVIDED FOR GENERAL INFORMATION. NOT ALL OF THE FOOTING SIZE IS REQUIRED. SEE FOUNDATION PLAN FOR FOOTING SIZE CALL-OUT

FOUNDATION AND LOWER FLOOR PLAN



1/4" = 1'-0"

- DO NOT SCALE DRAWINGS.
- VERIFY ALL DIMENSIONS IN FIELD. REFER TO ARCHITECTURAL PLAN FOR WALL LAYOUT.
- ALL POSTS AT THIS FRAMING LEVEL SHALL BE 4x4 U.N.O.
- TYPICAL EXTERIOR WALL SHALL BE FRAMED WITH 2x6 DF STUDS @ 16"oc. U.N.O. TYPICAL INTERIOR WALL SHALL BE FRAMED WITH 2x4 DF STUDS @ 16"oc U.N.O. REFER TO ARCHITECTURAL DRAWINGS FOR ADDITIONAL INFORMATION PERTAINING TO WALL THICKNESS.
- TYPICAL EXTERIOR WALL HEADERS SHALL BE FRAMED WITH (2) PILES OF 2x10 DF#2. TYPICAL INTERIOR WALL HEADERS SHALL BE FRAMED WITH (2) PILES OF 2x8 DF#2. U.N.O.
- SLAB ON GRADE SHALL BE 4" THICK, UNLESS OTHERWISE NOTED. SLAB SHALL BE REINFORCED WITH 6x6 W1.4xW1.4 WELDED WIRE MESH. PREPARE SUBGRADE BY PLACING AND COMPACTING A MINIMUM 4" OF CLEANED, CRUSHED ROCK AS A CAPILLARY BREAK. SUBGRADE BELOW SLAB SHALL BE UNDISTURBED NATIVE SOIL OR COMPACTED FILL.
- FOOTINGS SHALL BE PLACED ON UNDISTURBED NATIVE SOIL OR STRUCTURAL FILL COMPACTED TO 95% MAXIMUM WET DENSITY PLACED IN MAX. 12" LIFTS.
- BOTTOM OF ALL FOOTINGS SHALL BE 18" MINIMUM BELOW LOWEST ADJACENT GRADE. U.N.O.
- TYPICAL EXTERIOR WALL TO BE DETAILED AS SHEAR WALL TYPE W6 PER SHEAR WALL SCHEDULE. U.N.O.
- SEE SHEAR WALL FOUNDATION HOLDOWN SCHEDULE FOR MINIMUM HOLDOWN EMBEDMENT DEPTH AND MINIMUM FOOTING SIZE AROUND HOLDOWN ANCHOR.

REVISIONS:

REVISION 3-12-20


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DATE: 01-20-20

DRAWN:

CHECKED: C. BURT

S1.1

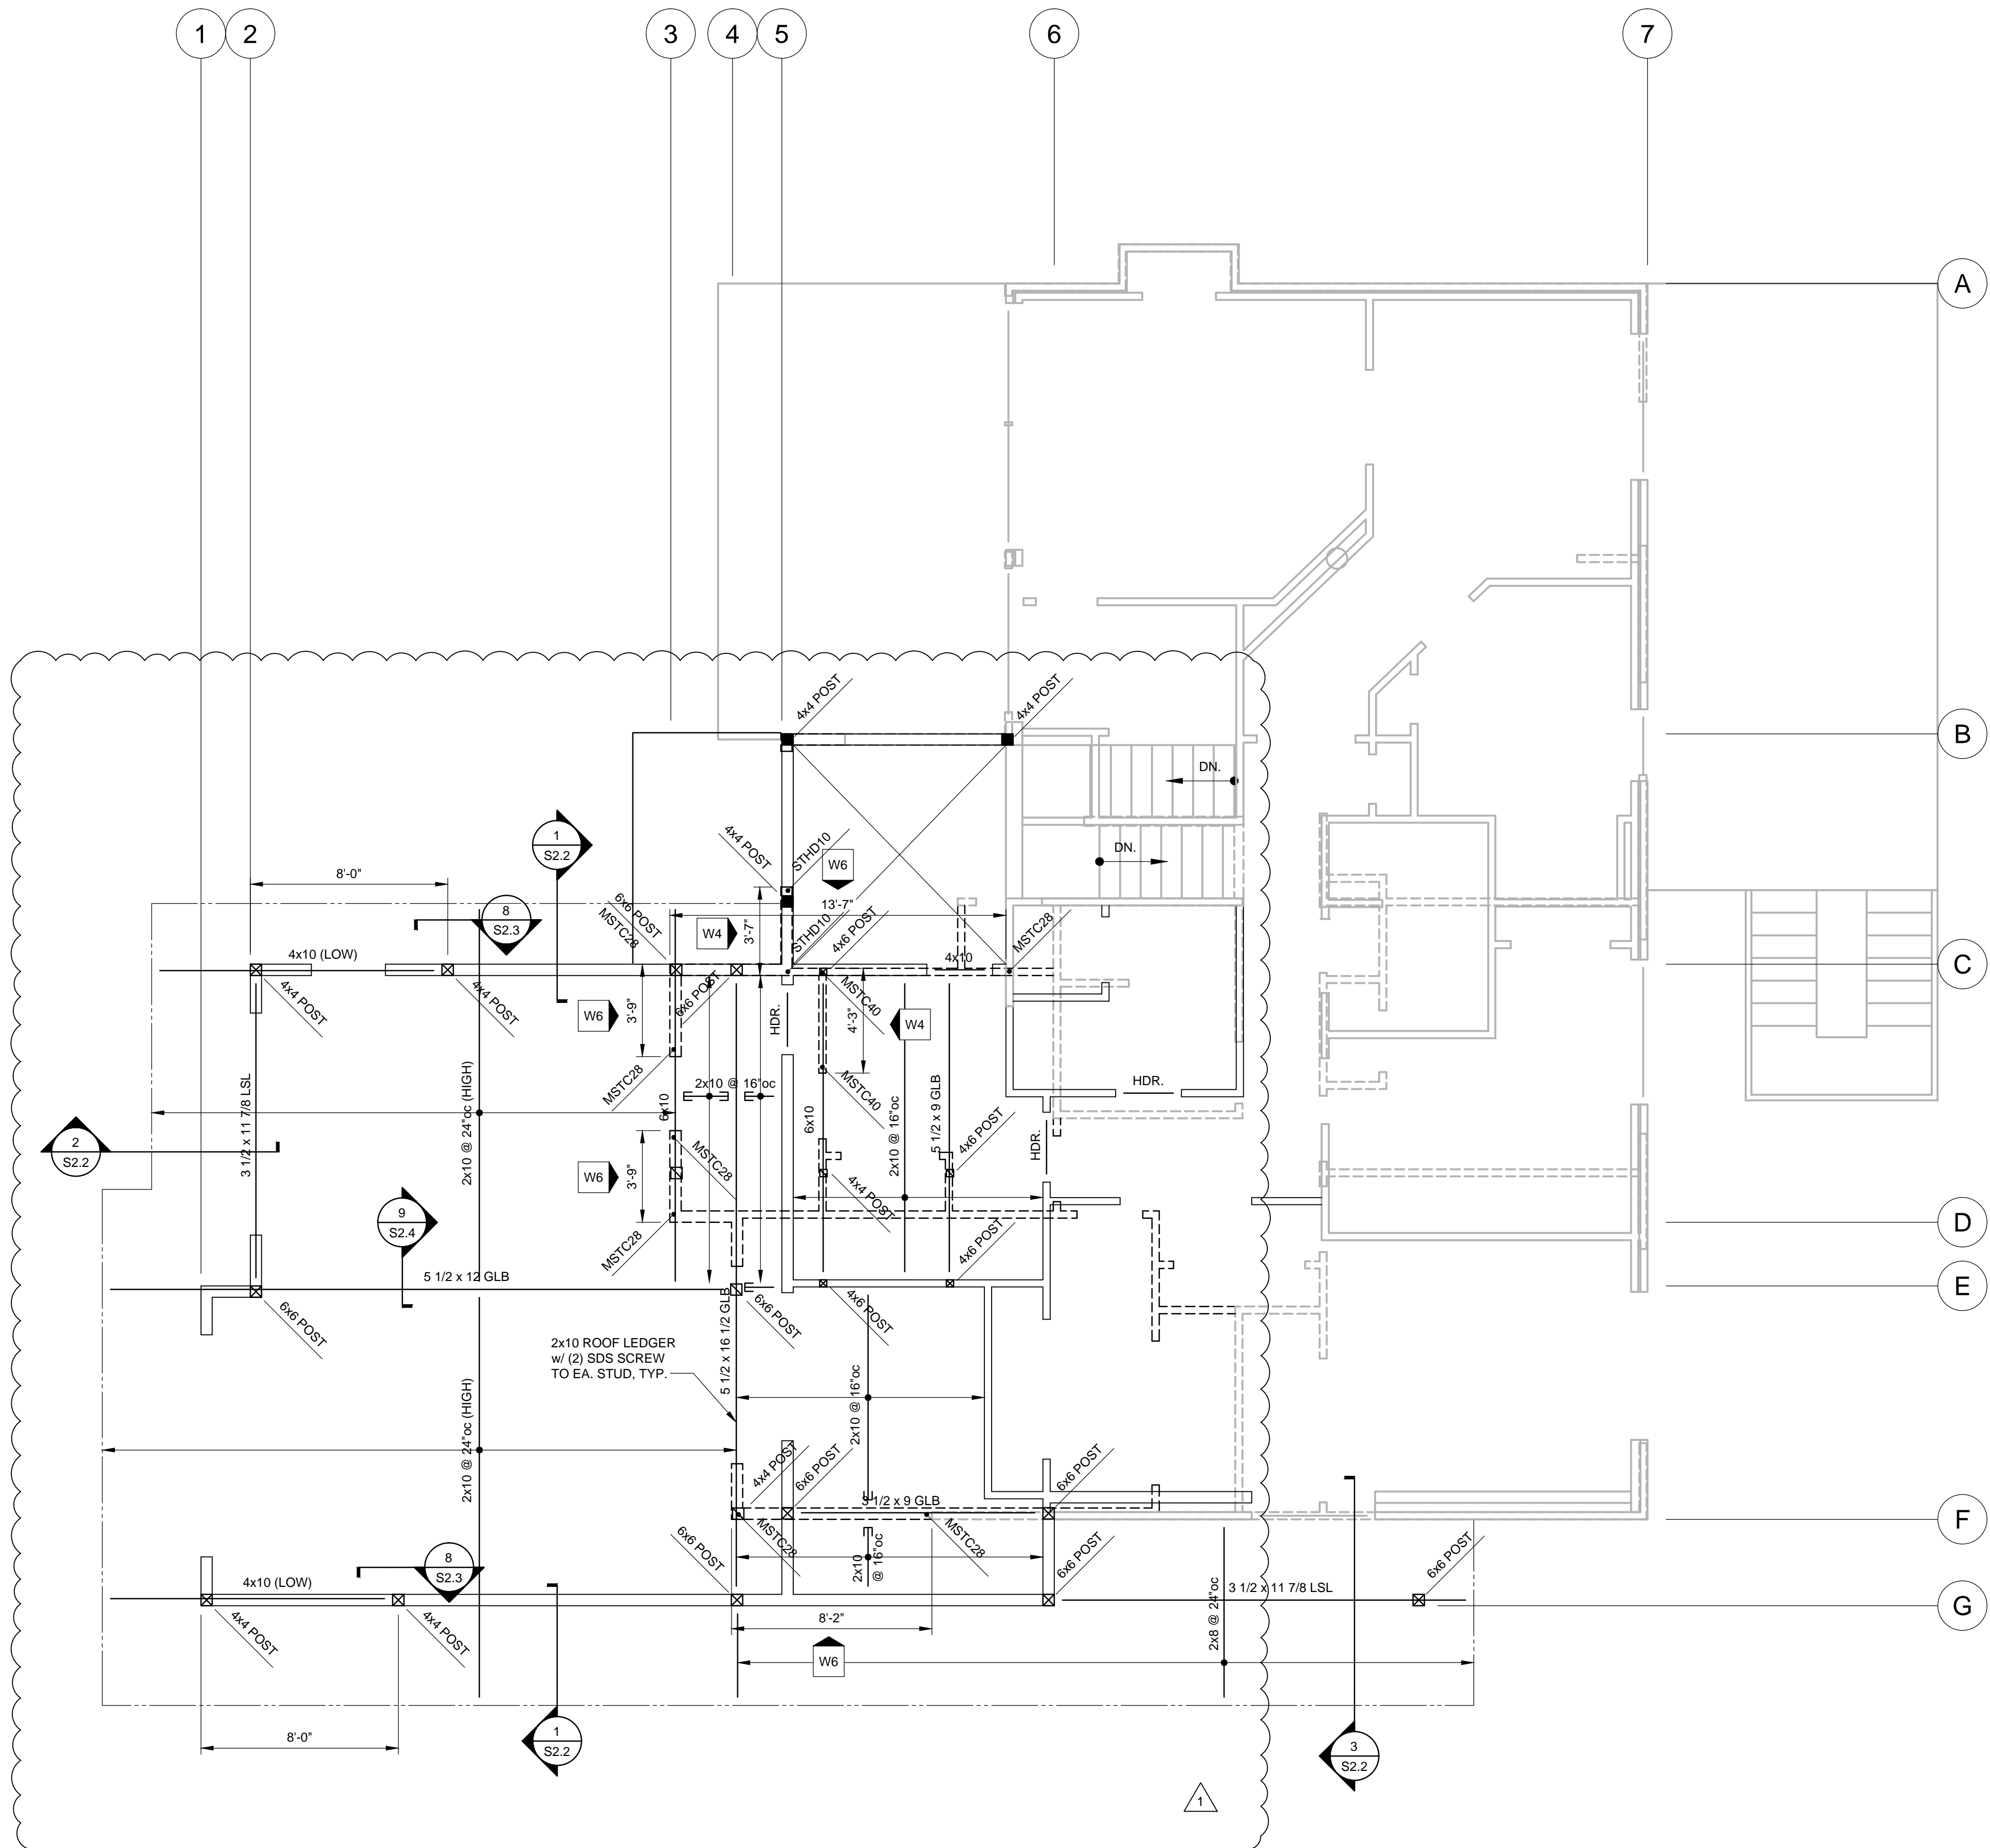

MAIN FLOOR FRAMING PLAN  1/4" = 1'-0"


1. DO NOT SCALE DRAWINGS
2. VERIFY ALL DIMENSIONS IN FIELD. REFER TO ARCHITECTURAL PLAN FOR WALL LAYOUT.
3. TYPICAL FLOOR FRAMING CONSISTS OF 3/4" T&G PLYWOOD SHEATHING ON FLOOR JOISTS. NAIL ALL SUPPORTED PANEL EDGES WITH 10d NAILS @ 6"oc & ALL INTERMEDIATE SUPPORTS WITH 10d NAILS @ 12"oc, PROVIDE BLOCKING FOR ALL EDGES.
4. TYPICAL FLOOR JOISTS SHALL BE 11 7/8" TJI 110 OR BETTER UNLESS OTHERWISE NOTED. REFER TO PLAN FOR JOIST SPACING (16"oc IF NOT NOTED). PROVIDE DOUBLE JOISTS UNDER ALL PARALLEL PARTITIONS THAT EXTEND OVER MORE THAN HALF THE JOIST LENGTH.
5. ALL POSTS AT THIS FRAMING LEVEL SHALL BE 4x4 U.N.O.
6. BEAM AT THIS FRAMING LEVEL SHALL BE 3 1/8 x 10 1/2 GLB, U.N.O.
7. TYPICAL EXTERIOR WALL SHALL BE FRAMED WITH 2x6 DF STUDS @ 16"oc, U.N.O. TYPICAL INTERIOR WALL SHALL BE FRAMED WITH 2x4 DF STUDS @ 16"oc U.N.O. REFER TO ARCHITECTURAL DRAWINGS FOR ADDITIONAL INFORMATION PERTAINING TO WALL THICKNESS.
8. TYPICAL EXTERIOR WALL HEADERS SHALL BE FRAMED WITH (2) PILES OF 2x10 DF#2. TYPICAL INTERIOR WALL HEADERS SHALL BE FRAMED WITH (2) PILES OF 2x8 DF#2, U.N.O.
9. TYPICAL EXTERIOR WALL TO BE DETAILED AS SHEAR WALL TYPE W6 PER SHEAR WALL SCHEDULE, U.N.O.




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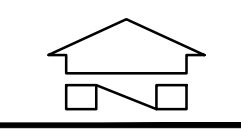
MAIN FLOOR FRAMING PLAN

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S1.2




ROOF FRAMING PLAN

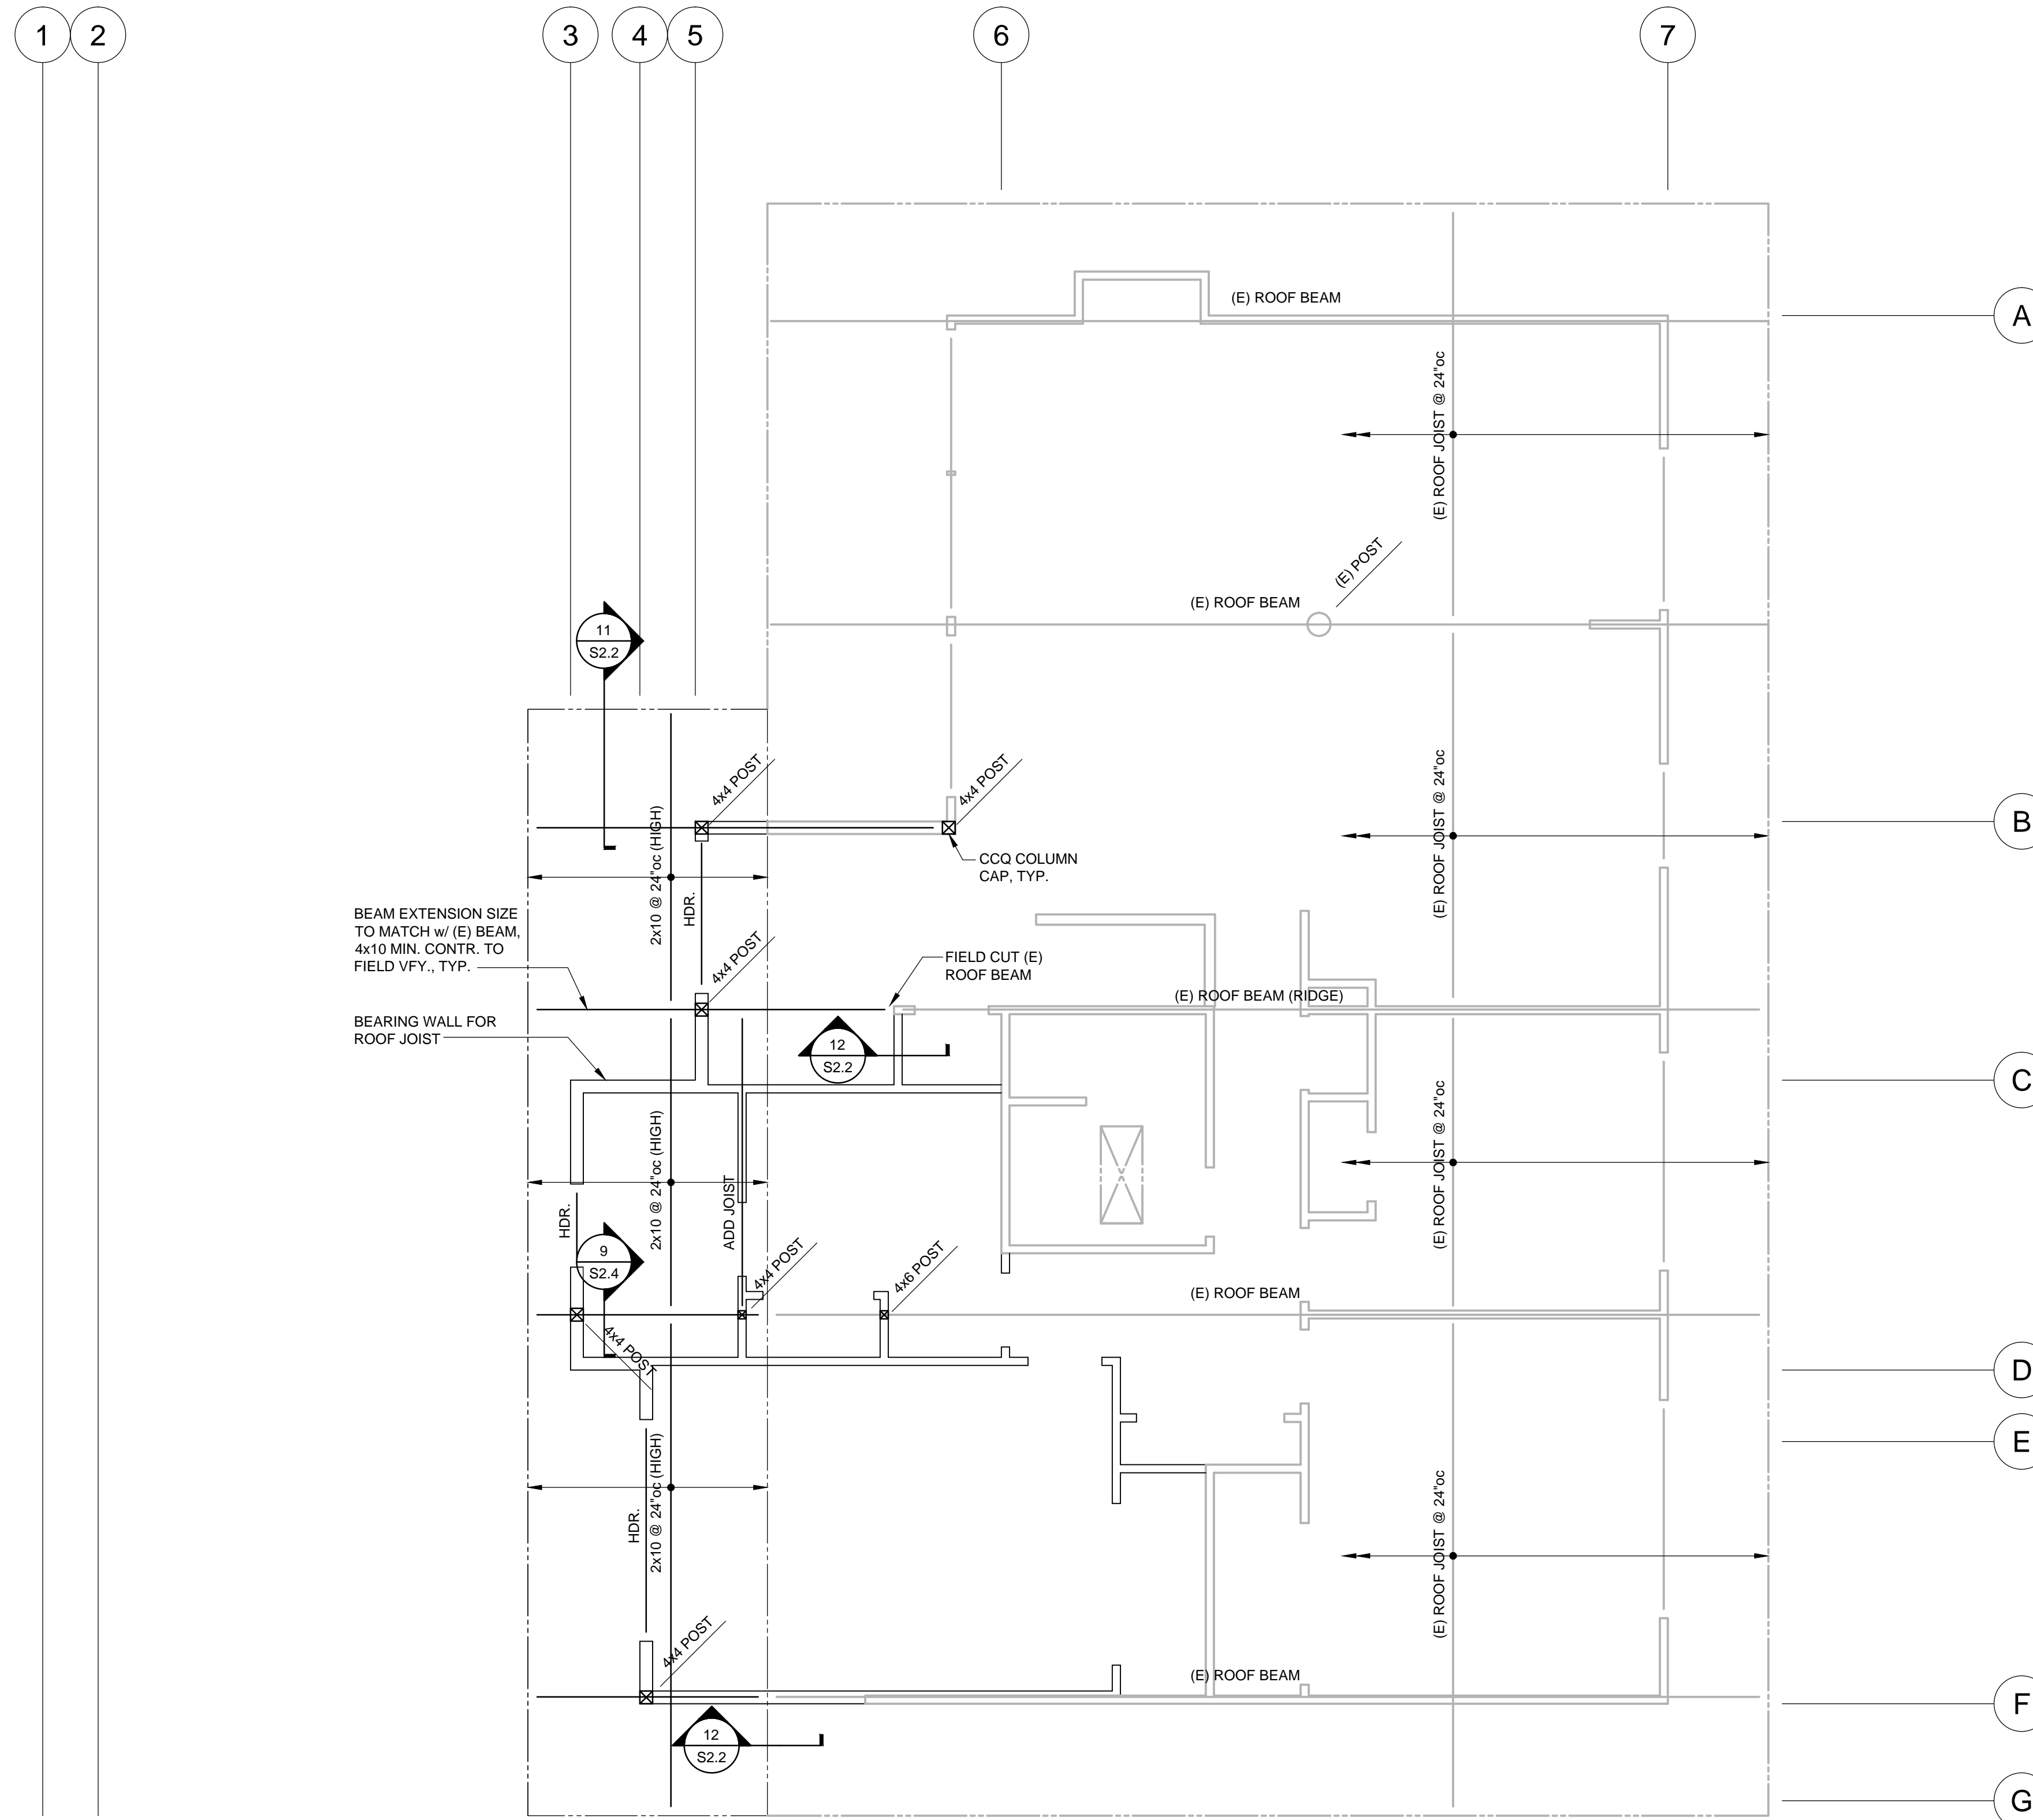

1/4" = 1'-0"

1. DO NOT SCALE DRAWINGS
2. VERIFY ALL DIMENSIONS IN FIELD. REFER TO ARCHITECTURAL PLAN FOR WALL LAYOUT.
3. TYPICAL ROOF FRAMING CONSISTS OF 5/8" PLYWOOD ON ENGINEERED WOOD TRUSSES OR RAFTERS. NAIL ALL SUPPORTED PANEL EDGES WITH 10d NAILS @ 6"oc & ALL INTERMEDIATE SUPPORTS WITH 10d NAILS @ 12"oc
4. TYPICAL ROOF TRUSSES SHALL BE SPACED @ 24"oc, U.N.O. TRUSS SUPPLIER TO SUBMIT A PROPOSED LAYOUT FOR REVIEW AND APPROVAL PRIOR TO FABRICATION. SEE GENERAL NOTES FOR MORE INFORMATION.
5. ALL POSTS AT THIS FRAMING LEVEL SHALL BE 4x4 U.N.O.
6. BEAM AT THIS FRAMING LEVEL SHALL BE 3 1/8 x 10 1/2 GLB, U.N.O.
7. TYPICAL EXTERIOR WALL SHALL BE FRAMED WITH 2x6 DF STUDS @ 16"oc, U.N.O. TYPICAL INTERIOR WALL SHALL BE FRAMED WITH 2x4 DF STUDS @ 16"oc U.N.O. REFER TO ARCHITECTURAL DRAWINGS FOR ADDITIONAL INFORMATION PERTAINING TO WALL THICKNESS.
8. TYPICAL EXTERIOR WALL HEADERS SHALL BE FRAMED WITH (2) PILES OF 2x10 DF#2. TYPICAL INTERIOR WALL HEADERS SHALL BE FRAMED WITH (2) PILES OF 2x8 DF#2, U.N.O.
9. TYPICAL EXTERIOR WALL TO BE DETAILED AS SHEAR WALL TYPE W6 PER SHEAR WALL SCHEDULE, U.N.O.

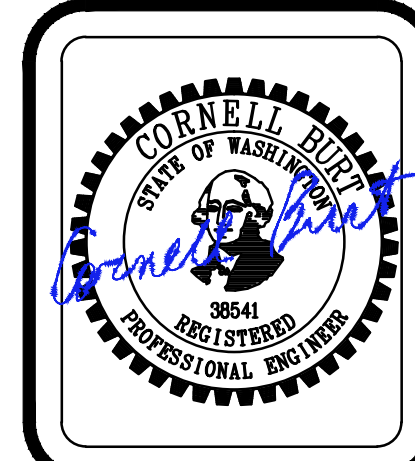


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ROOF FRAMING PLAN


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S1.3




TYPICAL S.W. FOOTING

1 SECTION
3/4" = 1'-0"

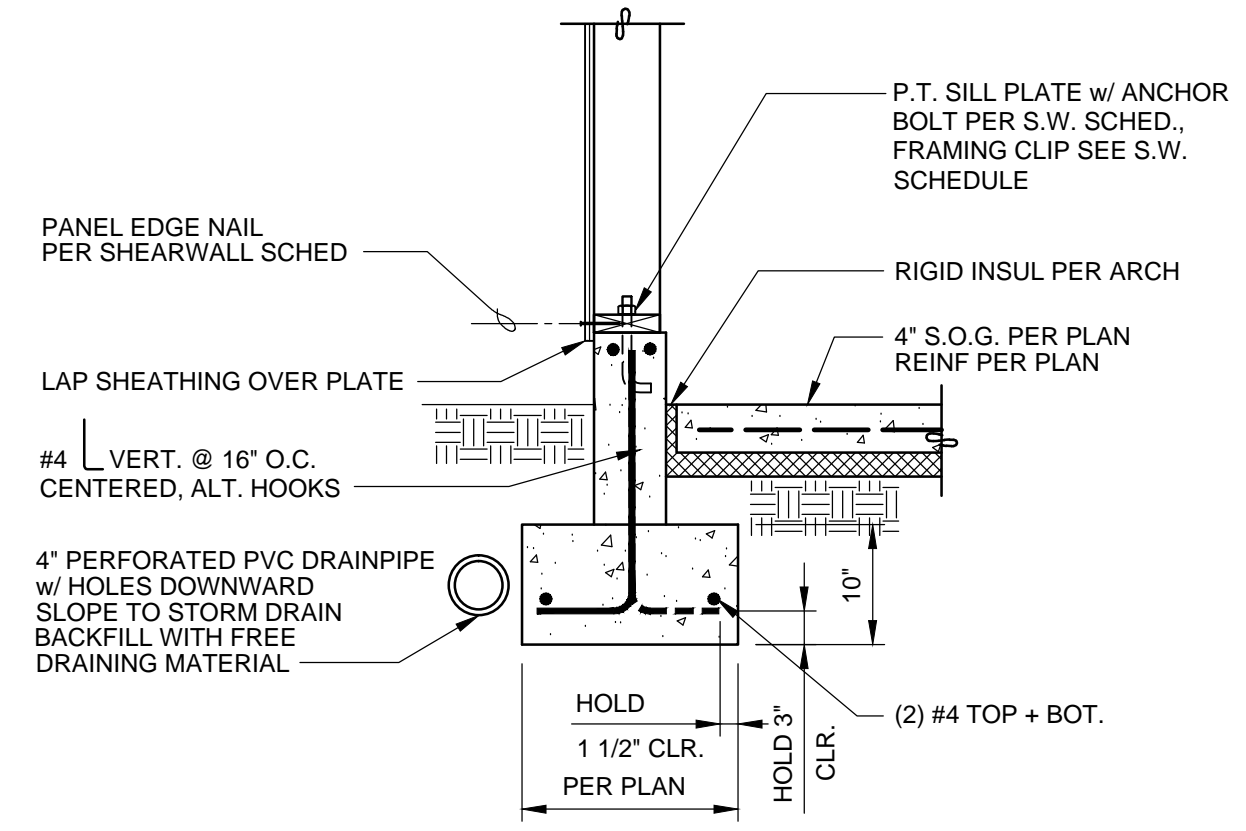

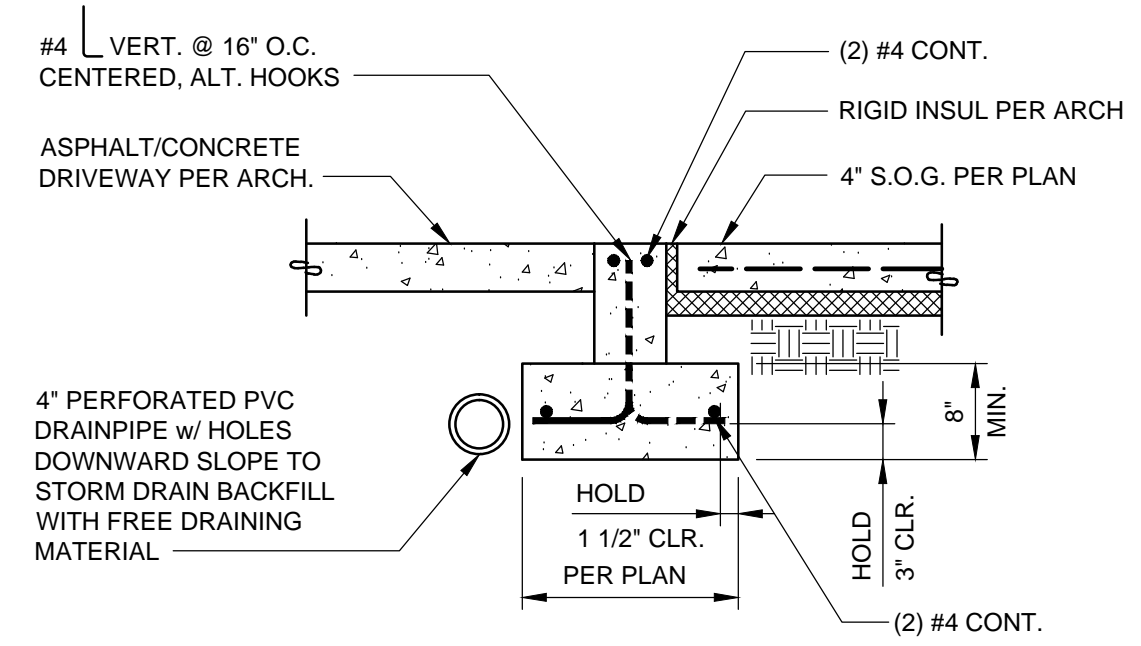
TYPICAL FOOTING AT GARAGE DOOR (S.O.G.)

2 SECTION
3/4" = 1'-0"

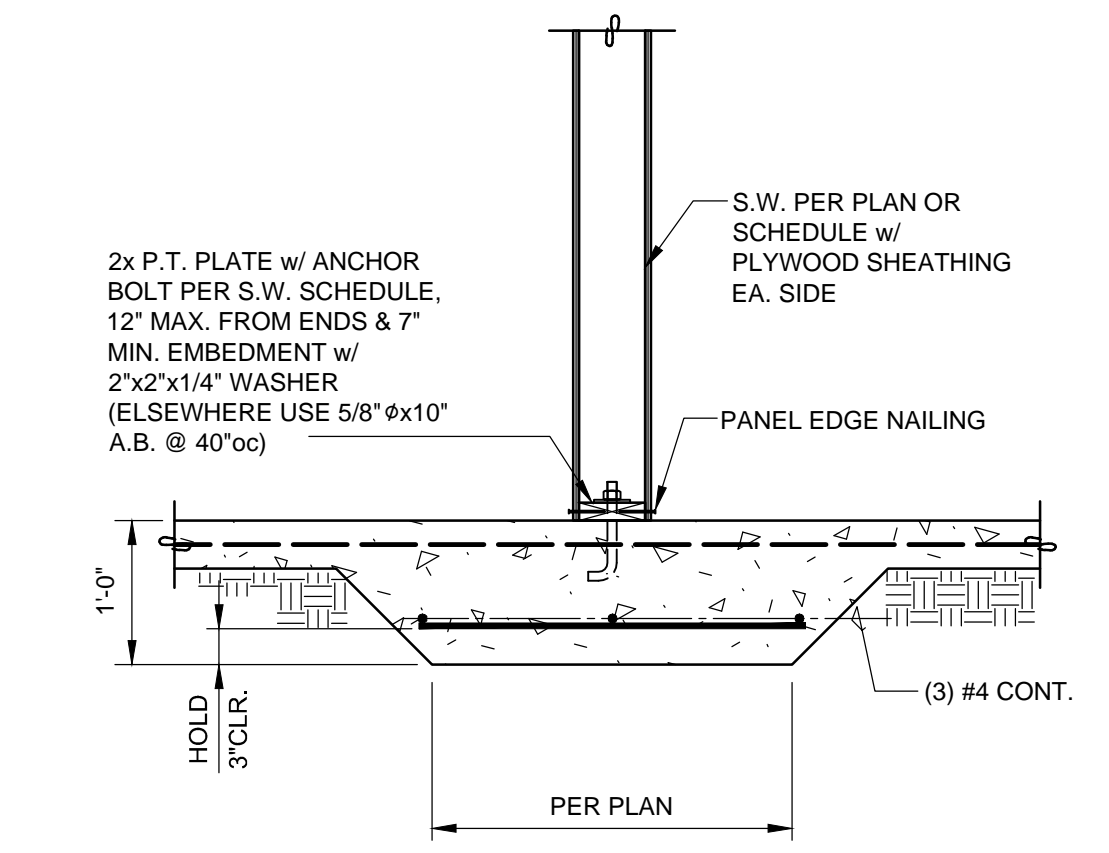


TYPICAL INTERIOR S.W. CONT. FOOTING (S.O.G.)

3 SECTION
3/4" = 1'-0"

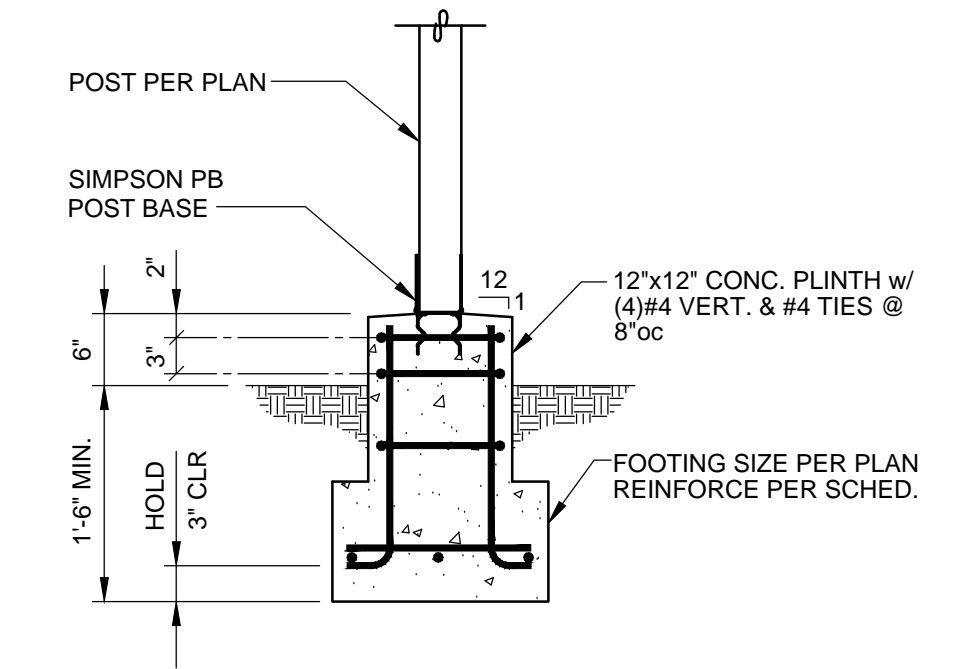


TYPICAL DECK POST FOOTING

4 SECTION
3/4" = 1'-0"

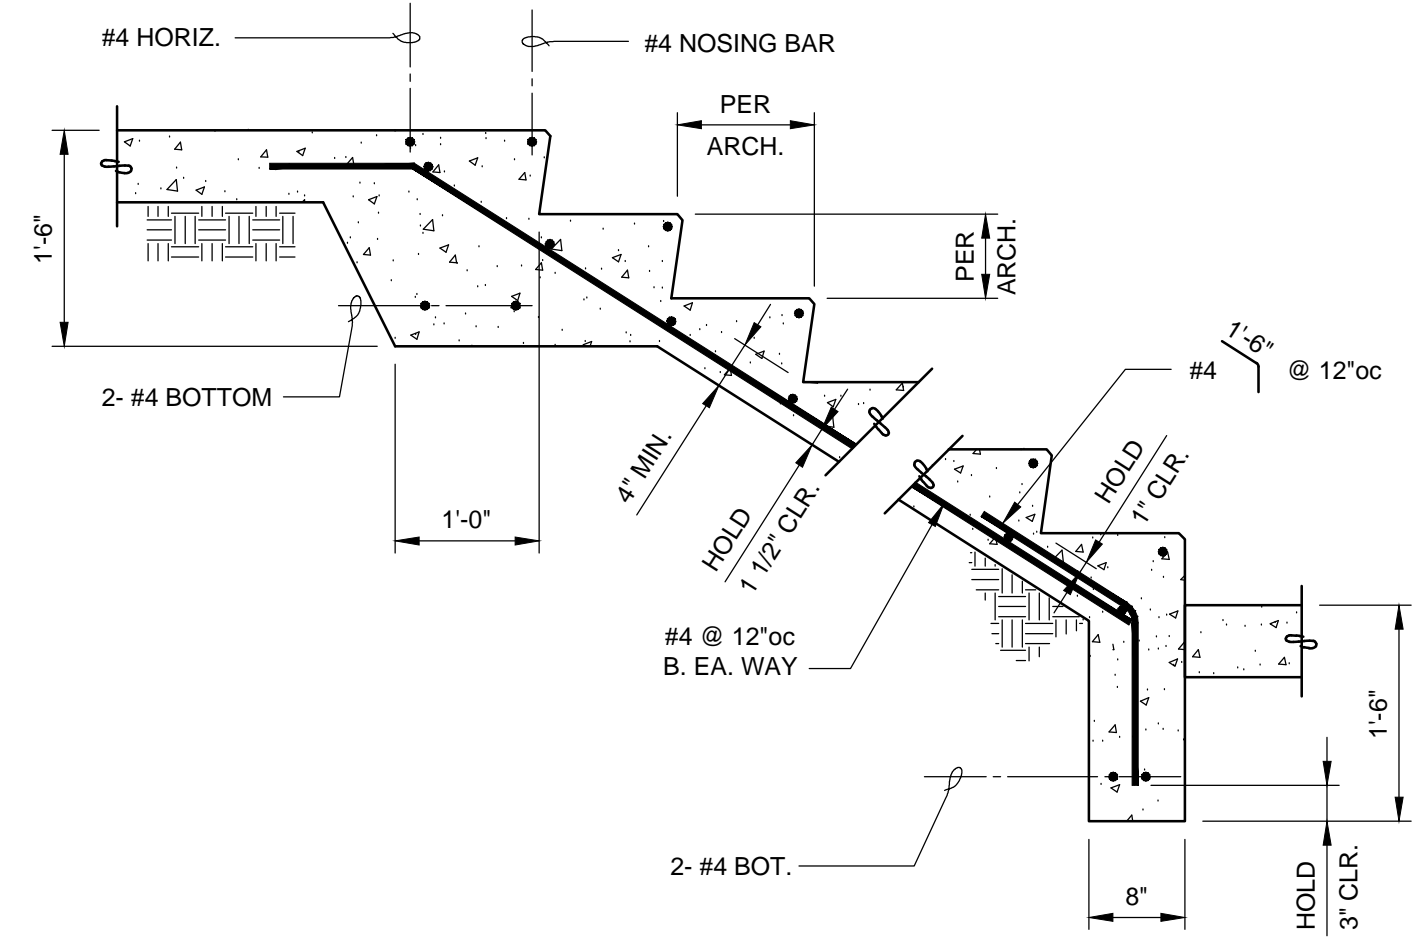


TYPICAL CONCRETE STAIR

5 SECTION
3/4" = 1'-0"

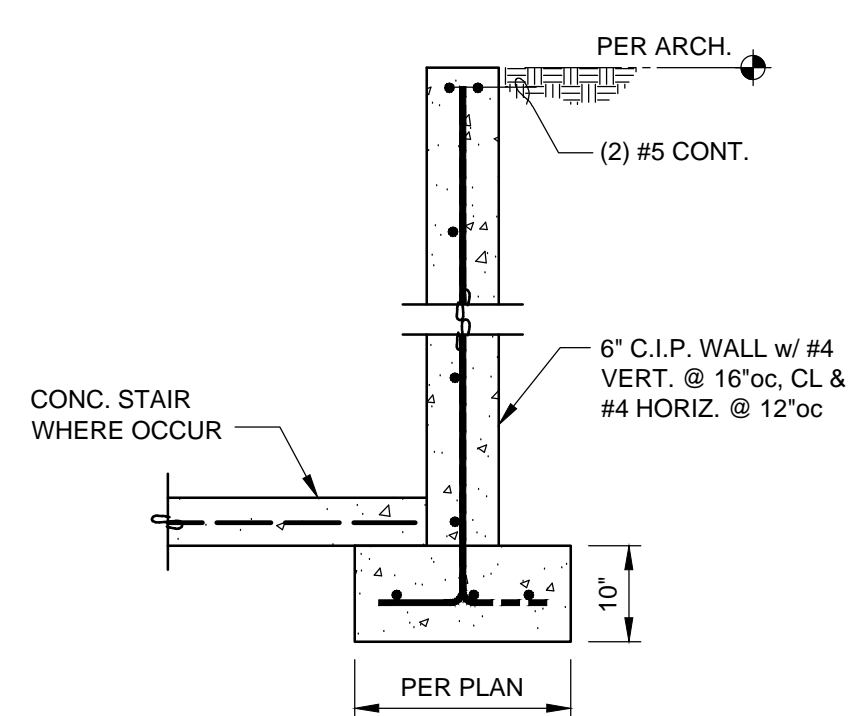


TYPICAL CONCRETE PLANTER

6 SECTION
3/4" = 1'-0"

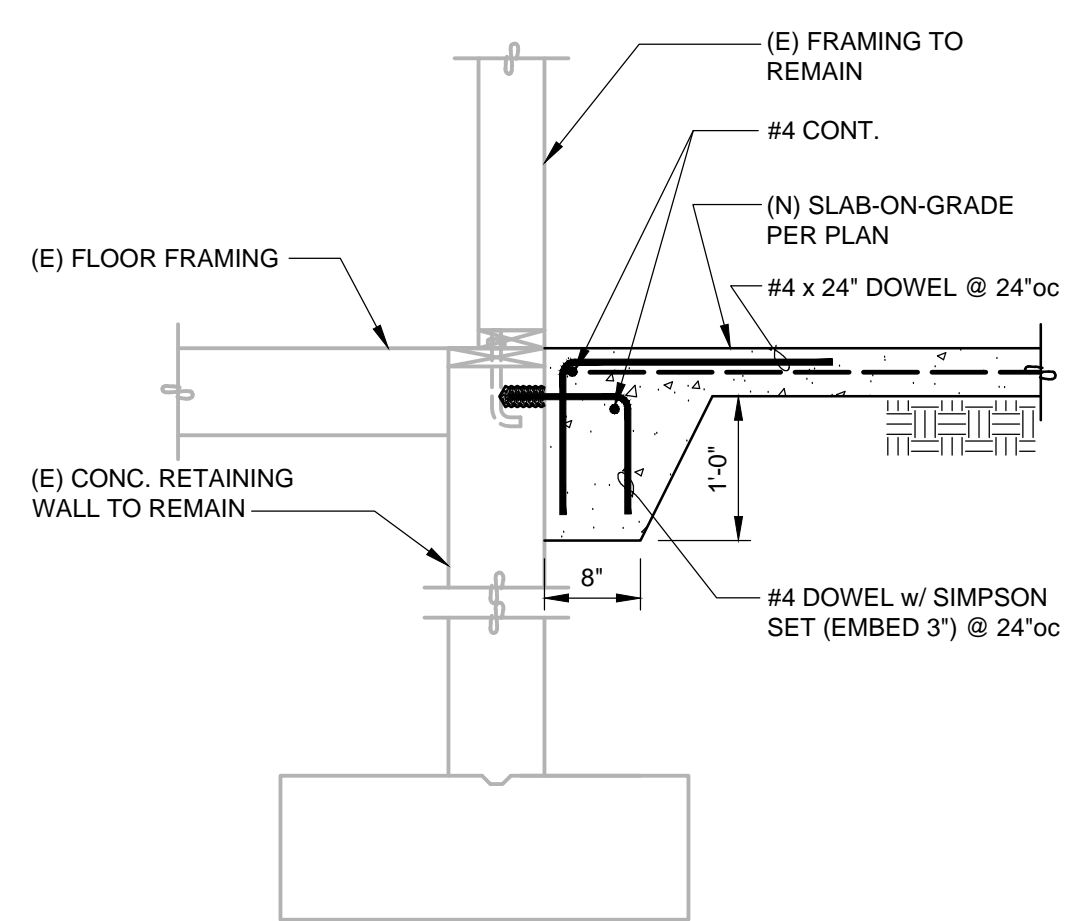


7 SECTION
3/4" = 1'-0"

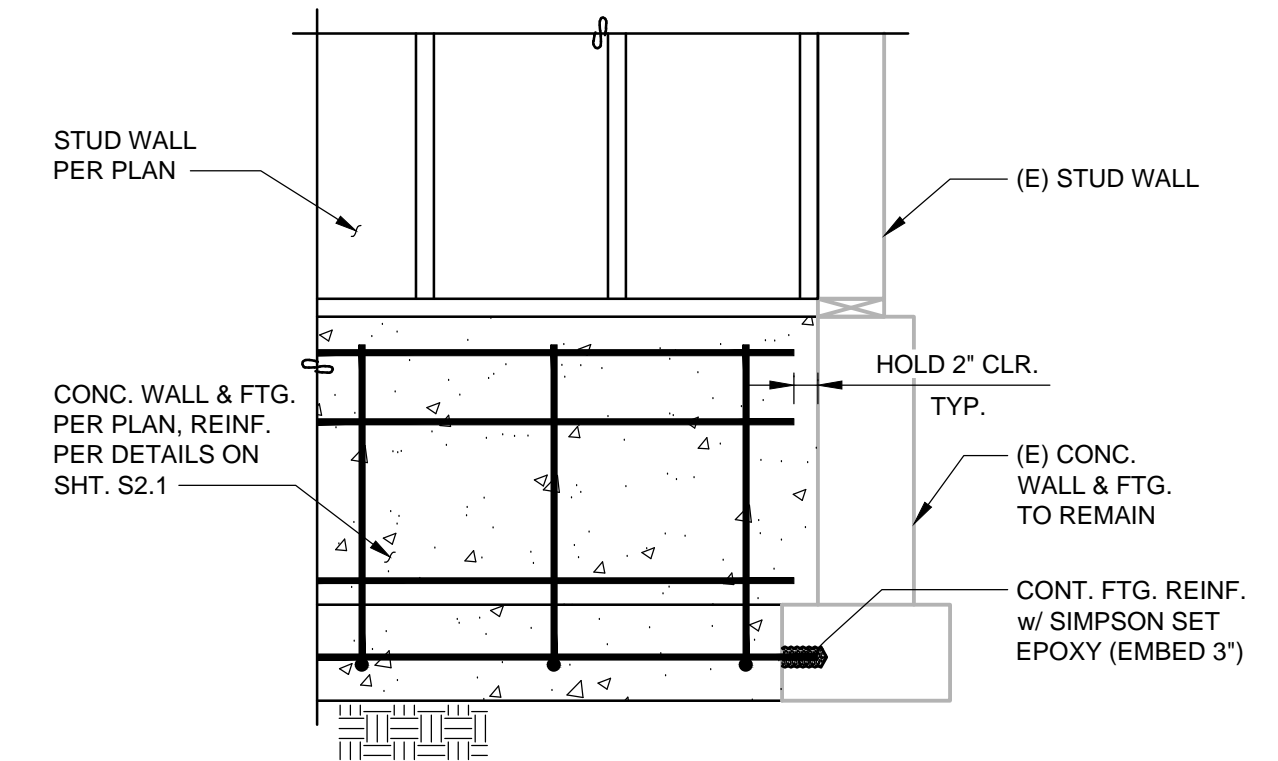


NEW WALL FOOTING TIE TO (E) FOOTING

8 SECTION
3/4" = 1'-0"

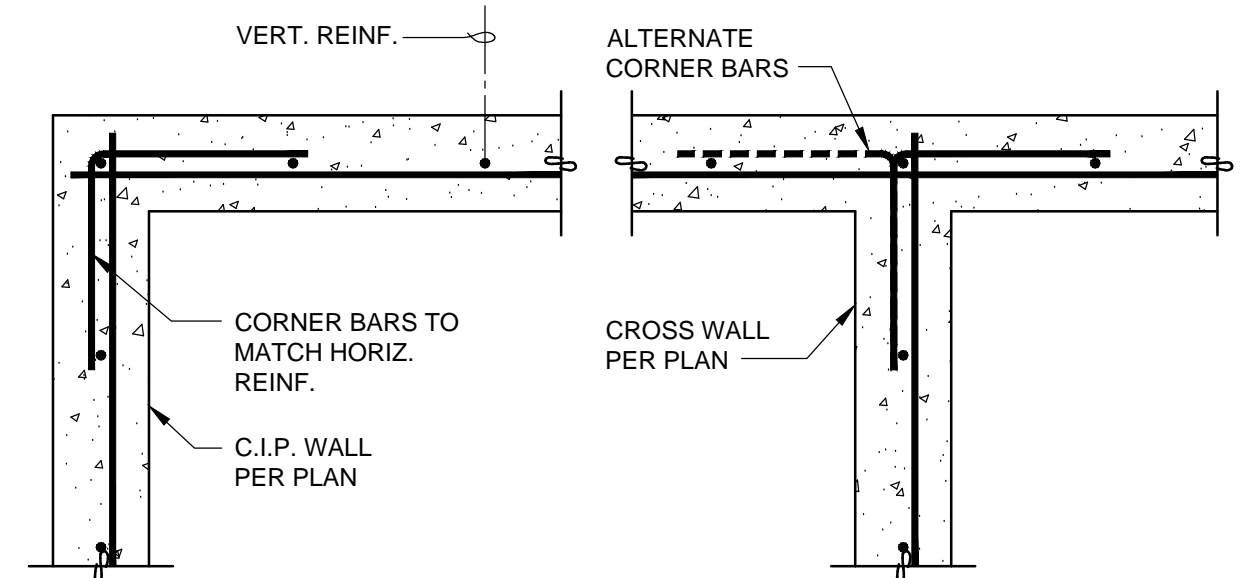

CORNER CONDITION AT C.I.P. WALL

9 SECTION
3/4" = 1'-0"

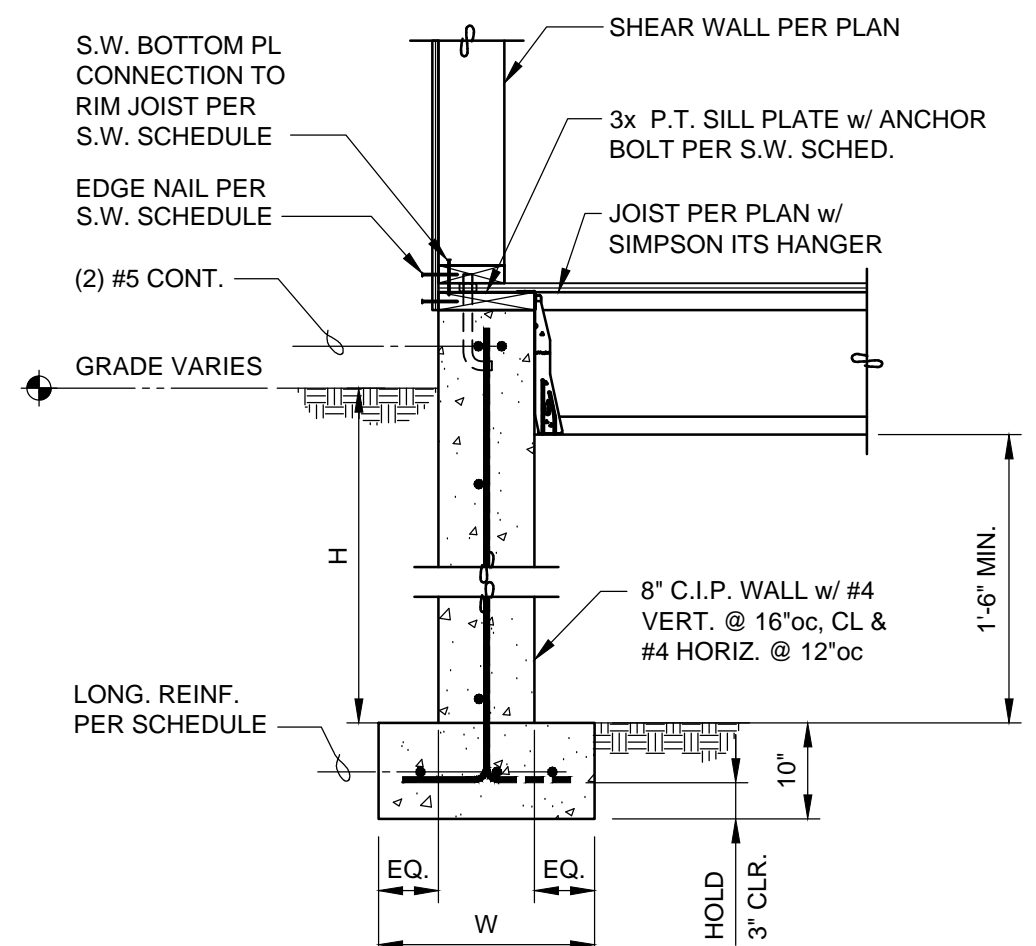


TYPICAL S.W. FOOTING (CRAWL SPACE)

10 SECTION
3/4" = 1'-0"


8" CRAWLSPACE WALL SCHEDULE

DIMENSIONS		STEM WALL REINF.		FOOTING REINF.
H	W	VERT.	HORIZ	LONG.
2'-0"	1'-6"	#4 @ 16"oc	#4 @ 12"oc	(3)#4
3'-0"	2'-2"	#4 @ 16"oc	#4 @ 12"oc	(4)#4
4'-0"	3'-8"	#4 @ 16"oc	#4 @ 12"oc	(5)#4
5'-0"	5'-2"	#4 @ 16"oc	#4 @ 12"oc	(7)#4

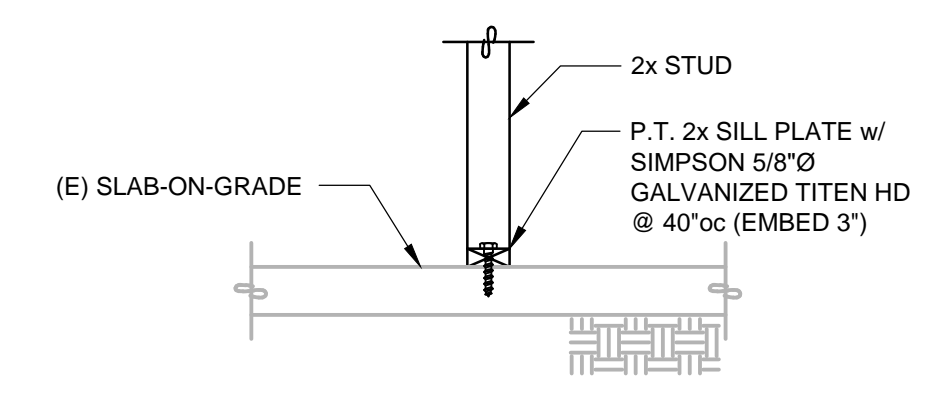

TYPICAL NON-BEARING WALL ANCHORAGE

12 SECTION
3/4" = 1'-0"

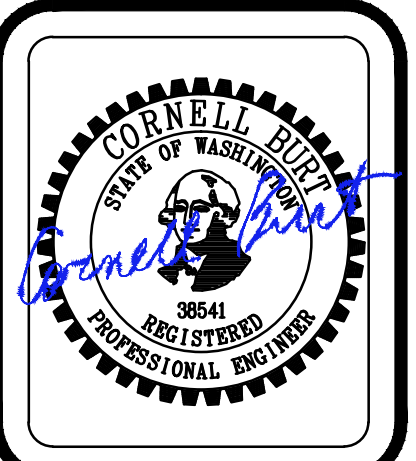


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MERCER ISLAND, WA 98040

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DATE: 01-20-20
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CHECKED: C. BURT


S2.1



TYPICAL ROOF RAFTER

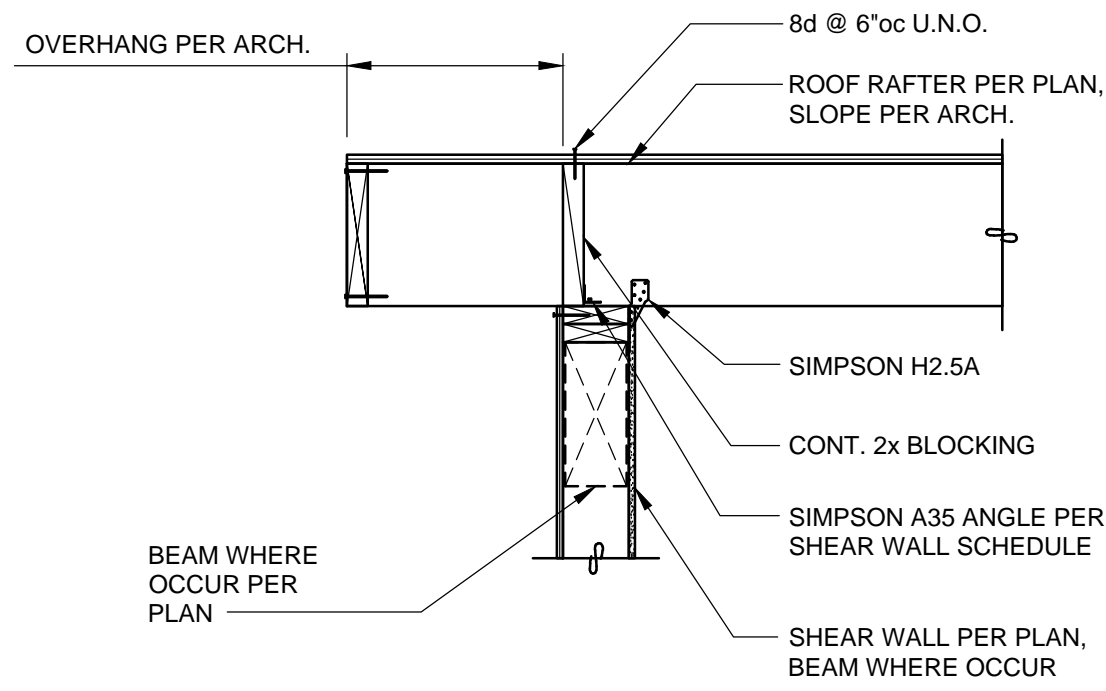1 SECTION


3/4" = 1'-0"

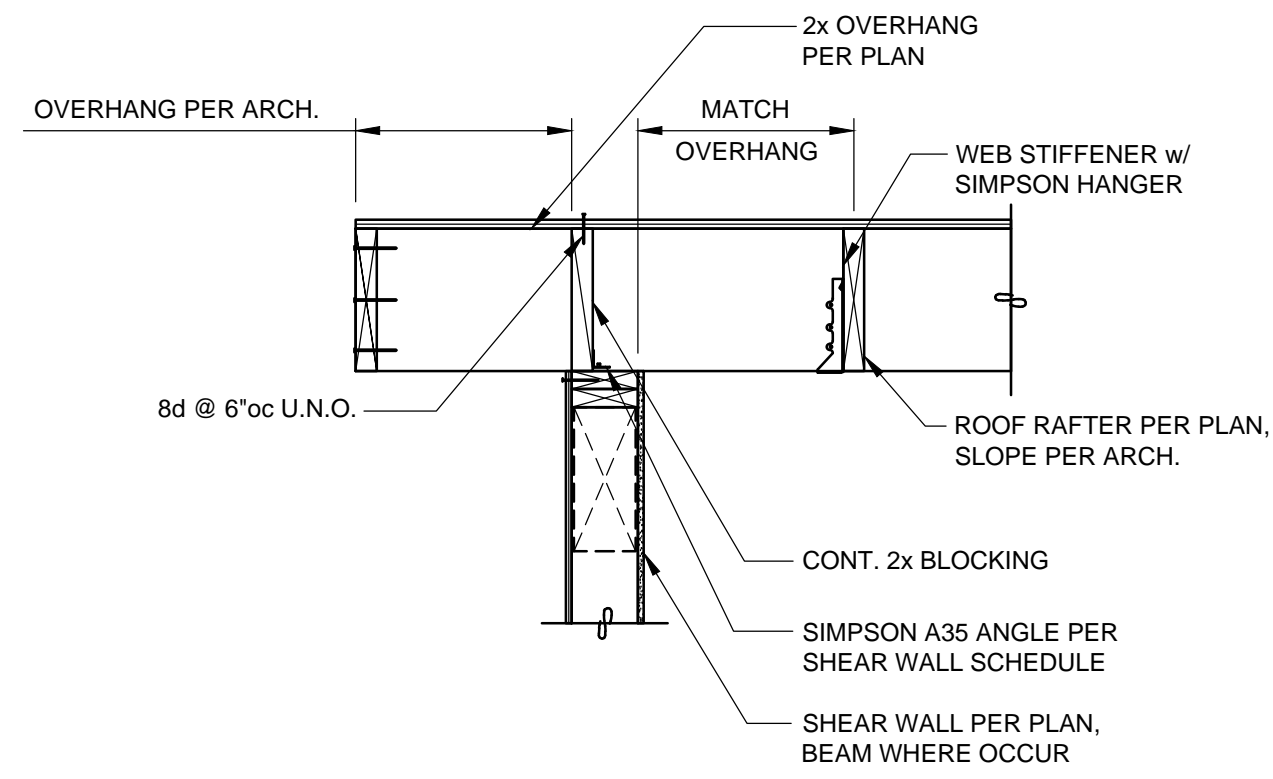

TYPICAL ROOF RAFTER


2 SECTION

3/4" = 1'-0"

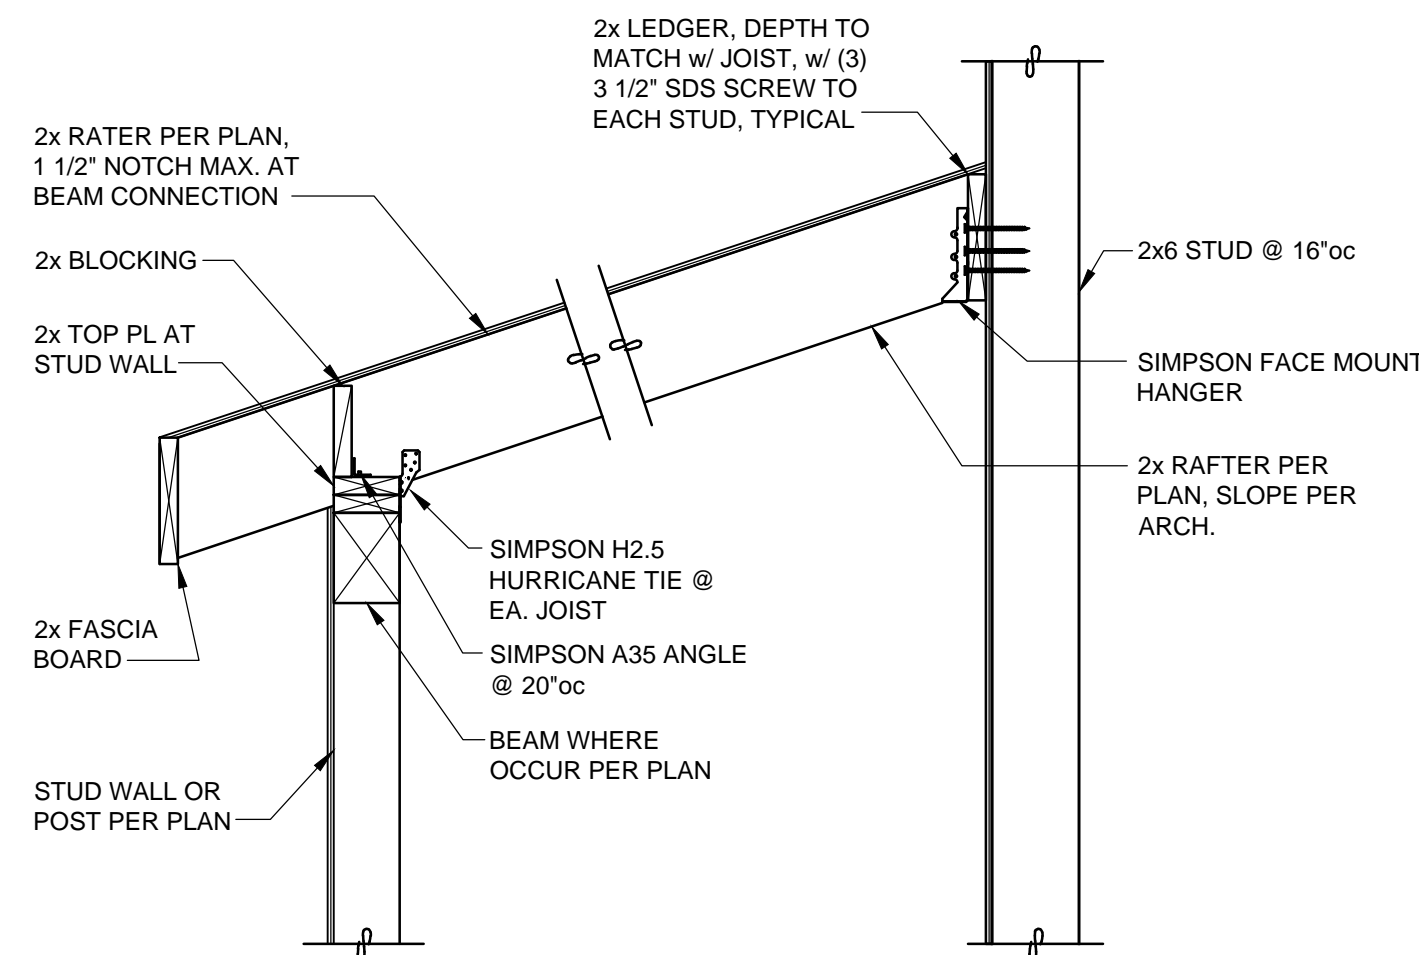

3 SECTION


3/4" = 1'-0"

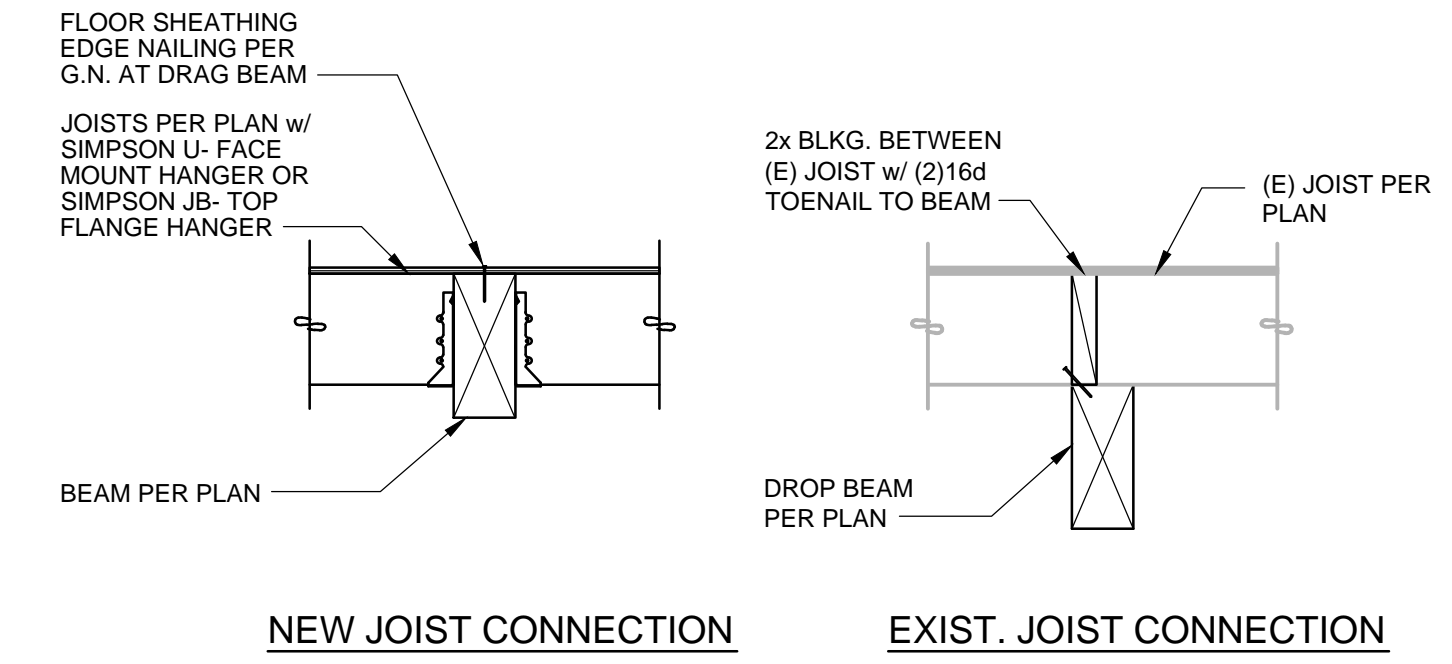

TYPICAL JOIST TO BEAM CONNECTION

4 SECTION


3/4" = 1'-0"

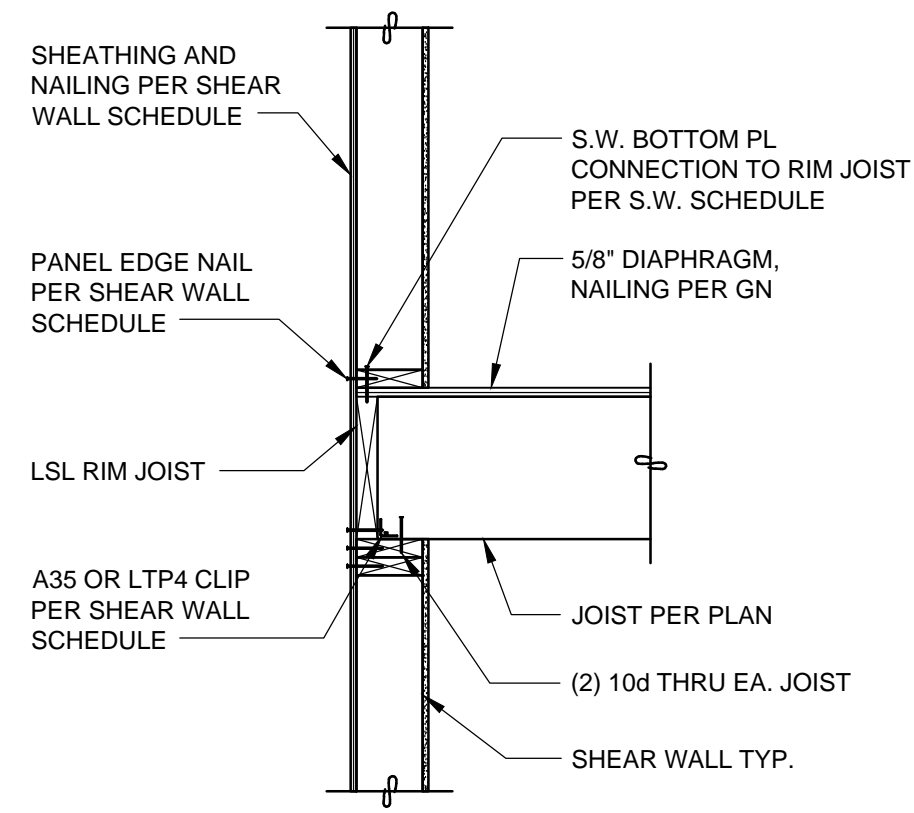

TYPICAL S.W. PERPENDICULAR FRAMING

5 SECTION


3/4" = 1'-0"

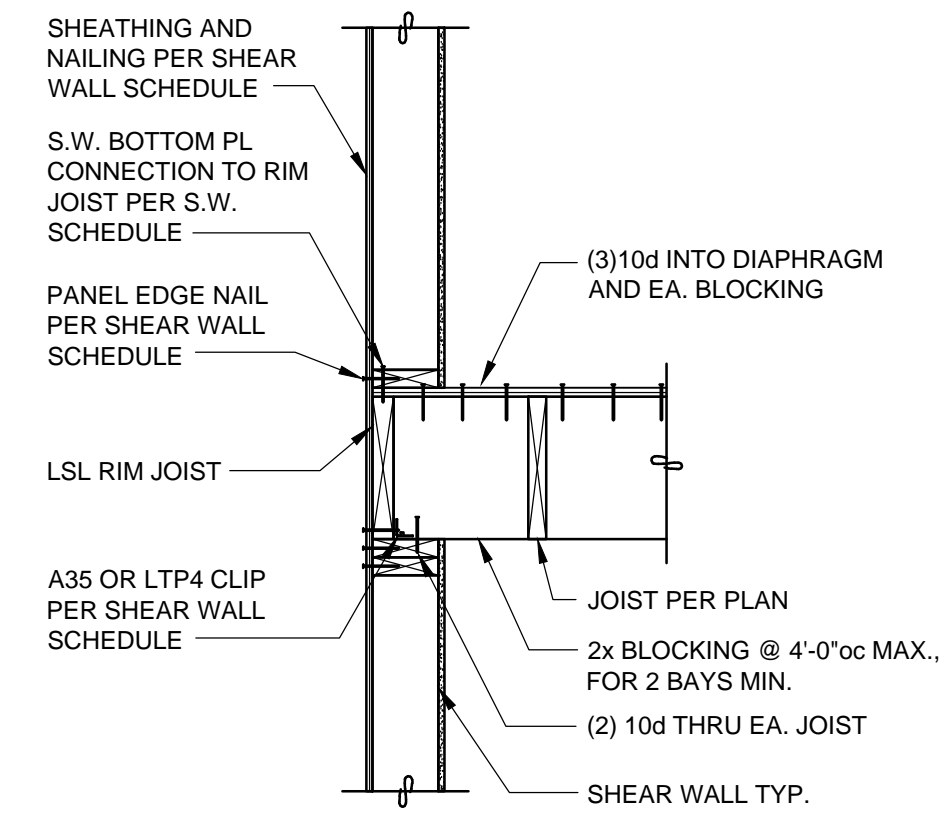

TYPICAL S.W. PARALLEL FRAMING

6 SECTION


3/4" = 1'-0"

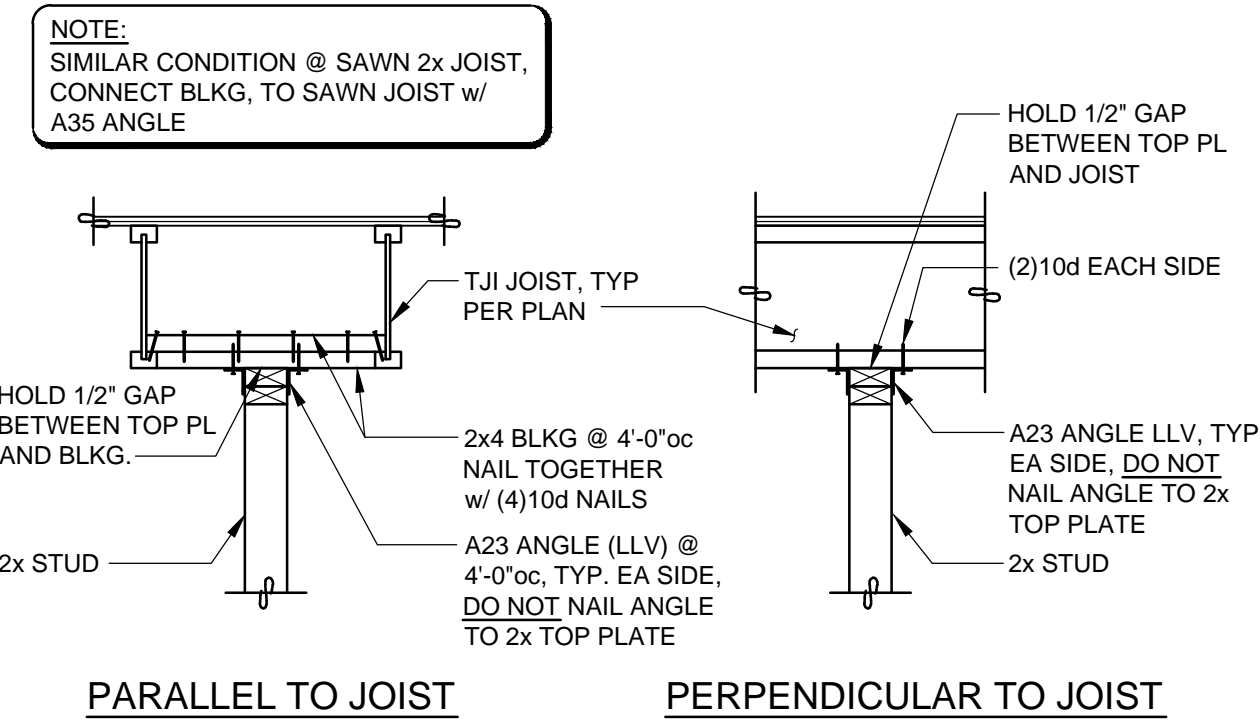

TYPICAL TOP OF NON-BEARING WALL ANCHORAGE

7 SECTION


3/4" = 1'-0"

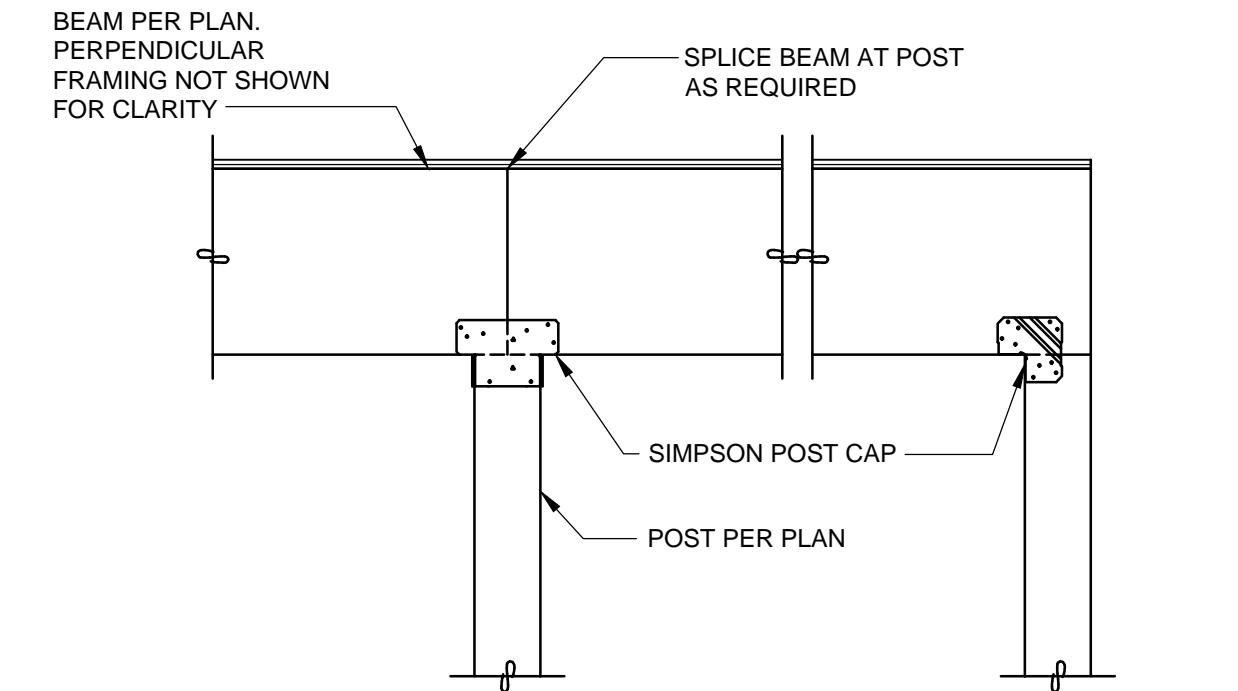

TYPICAL BEAM TO WOOD POST CONNECTION

8 SECTION


3/4" = 1'-0"

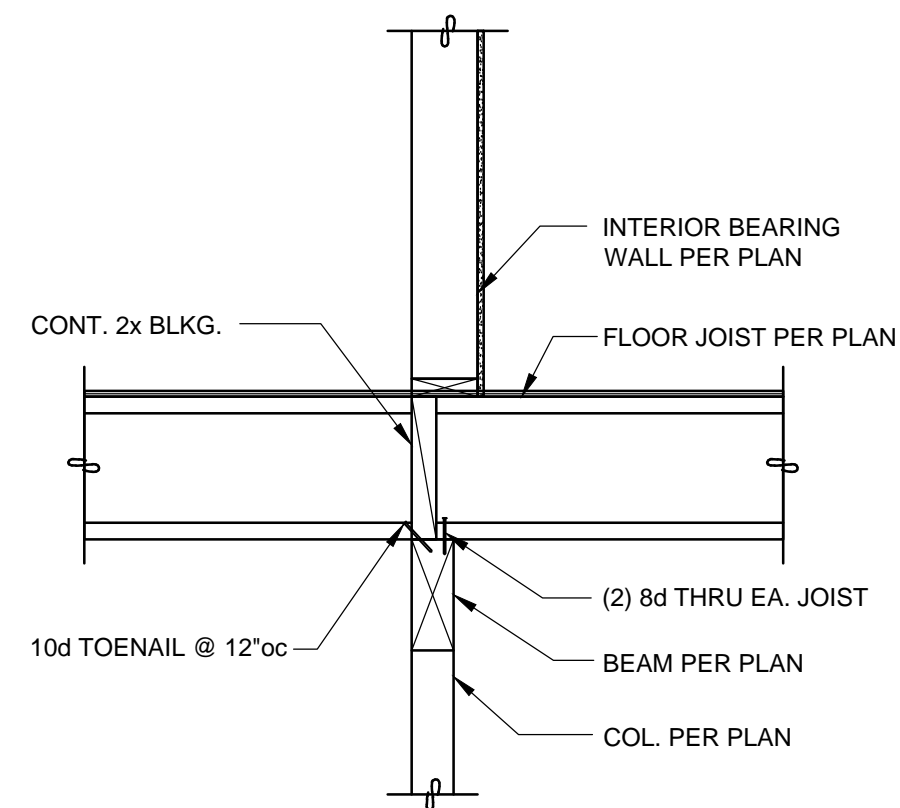

TYPICAL BEARING WALL BEAM SUPPORT

9 SECTION


3/4" = 1'-0"

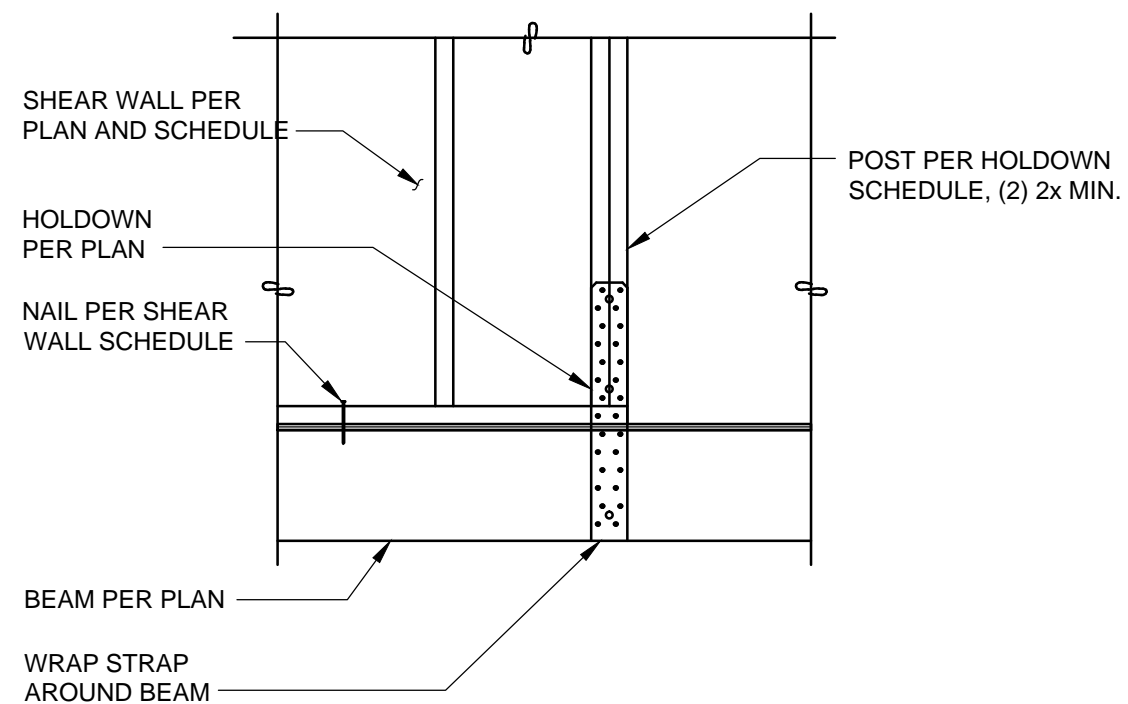

TYPICAL HOLDDOWN AT BEAM


10 SECTION

3/4" = 1'-0"

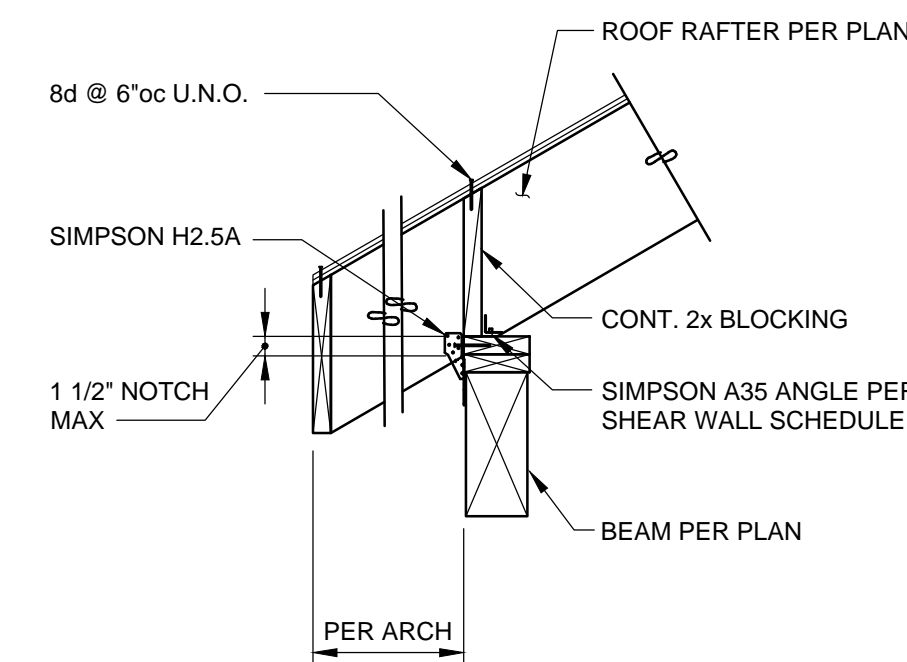

11 SECTION

3/4" = 1'-0"

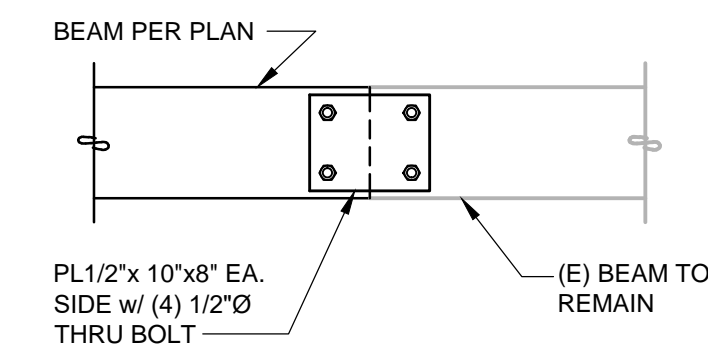

12 SECTION

3/4" = 1'-0"



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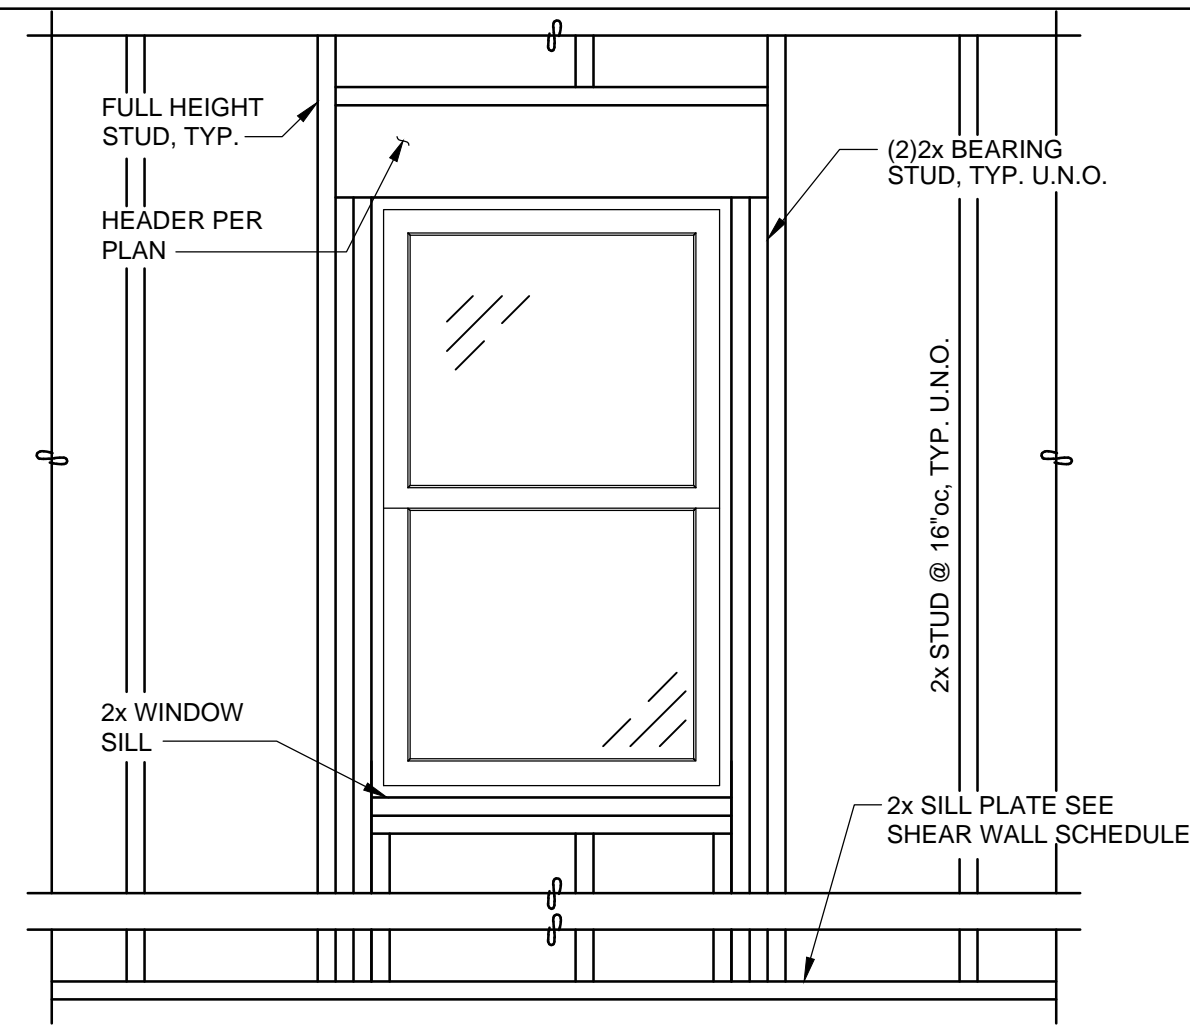
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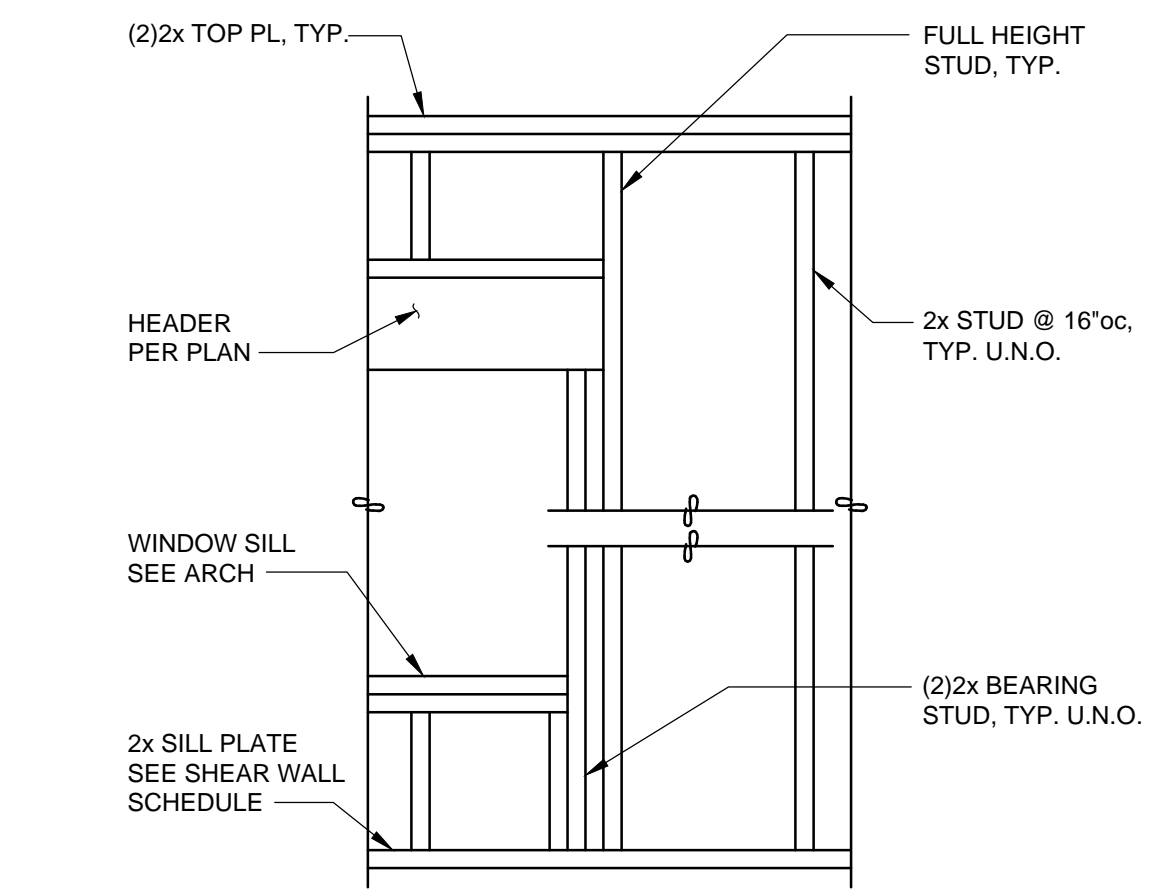
S2.2



TYPICAL STUD FRAMING DETAIL @ OPENING

1 SECTION


3/4" = 1'-0"



TYPICAL STUD FRAMING DETAIL

2 SECTION


3/4" = 1'-0"

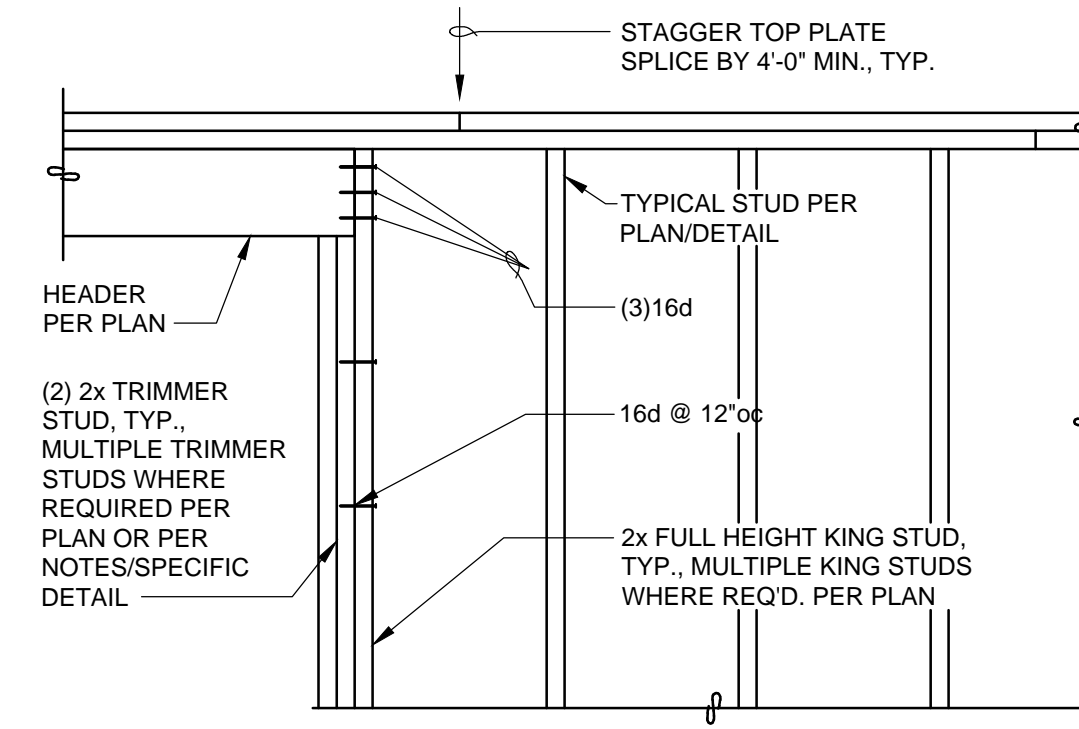

TYPICAL HEADER SUPPORT DETAIL

3 SECTION


3/4" = 1'-0"

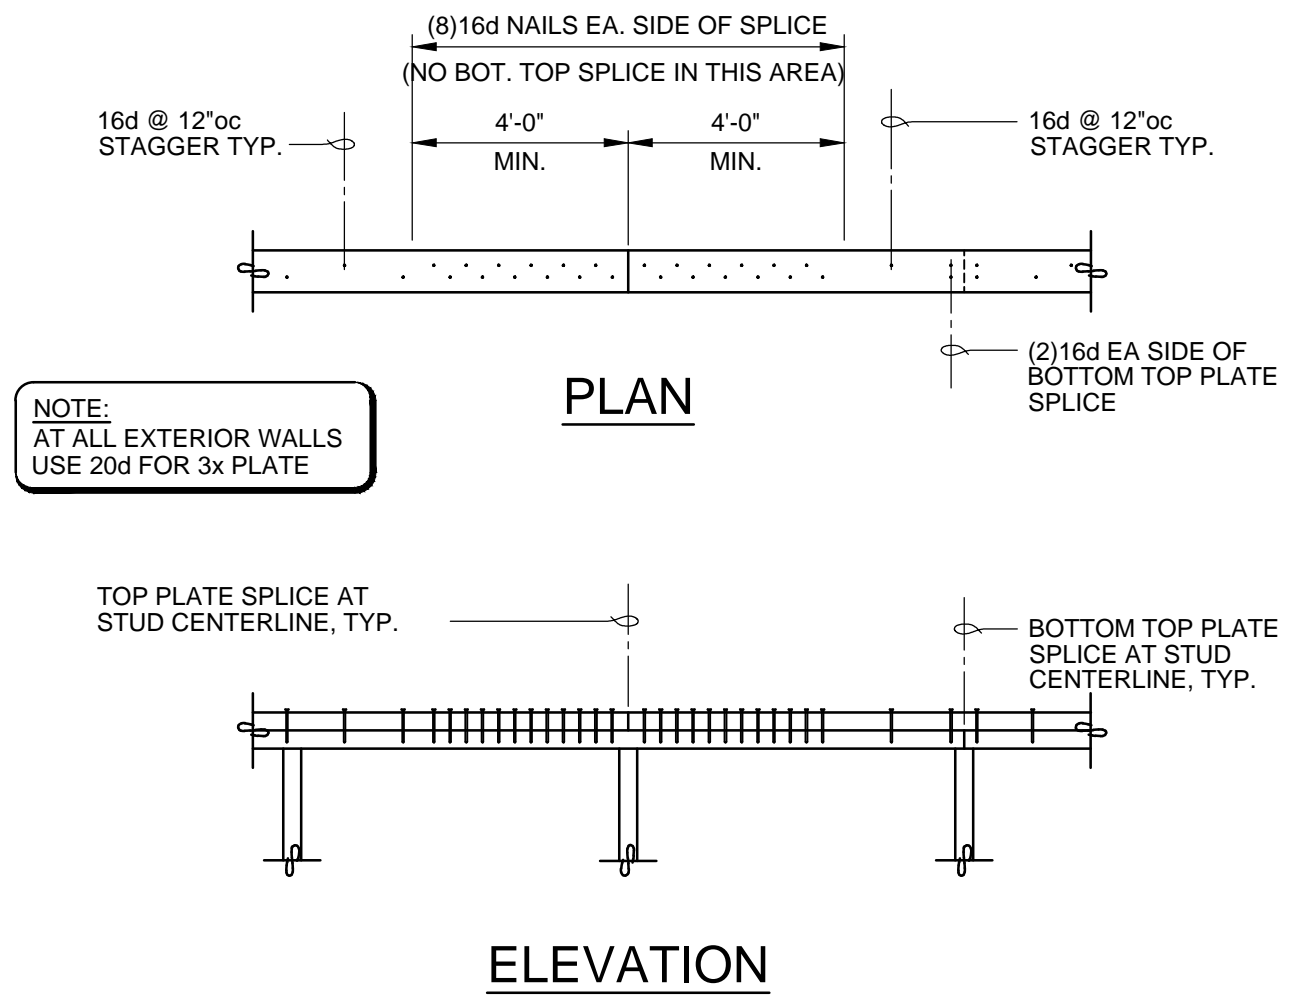

TYPICAL STUD WALL TOP PLATE SPLICE

4 SECTION


3/4" = 1'-0"

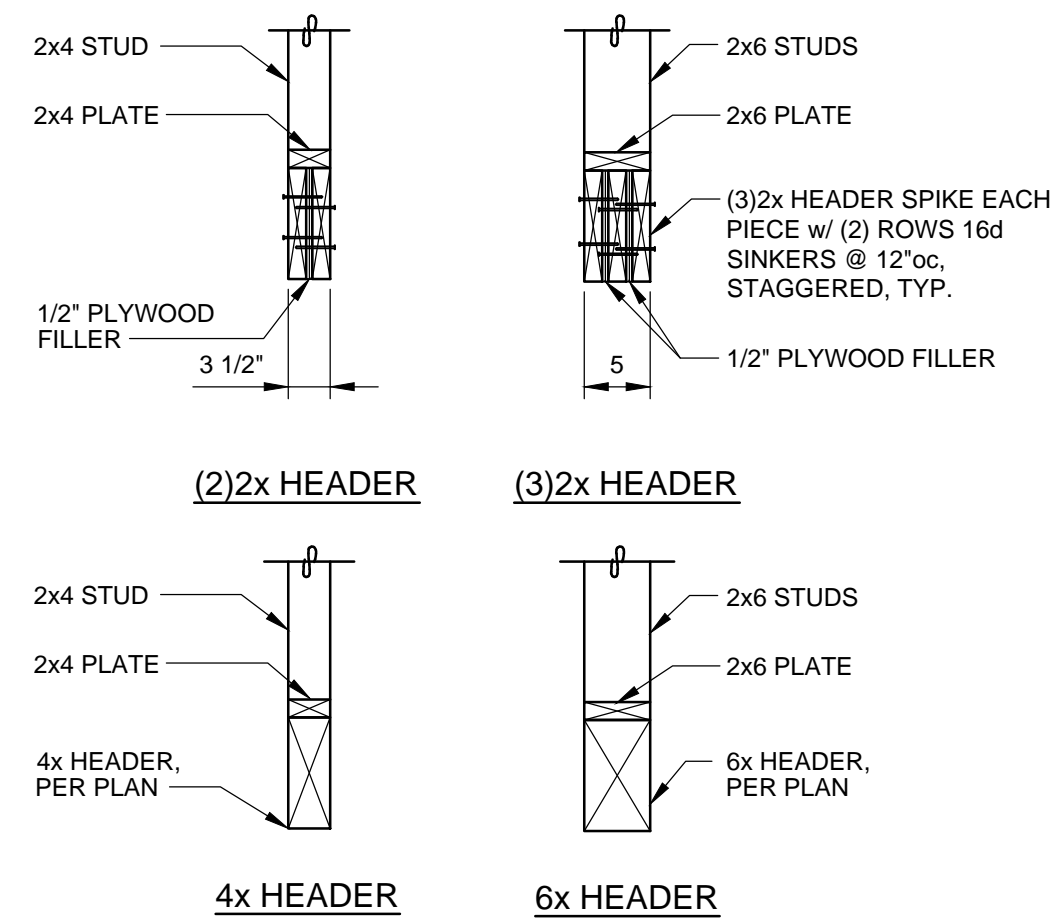

TYPICAL HEADER DETAIL

5 SECTION


3/4" = 1'-0"

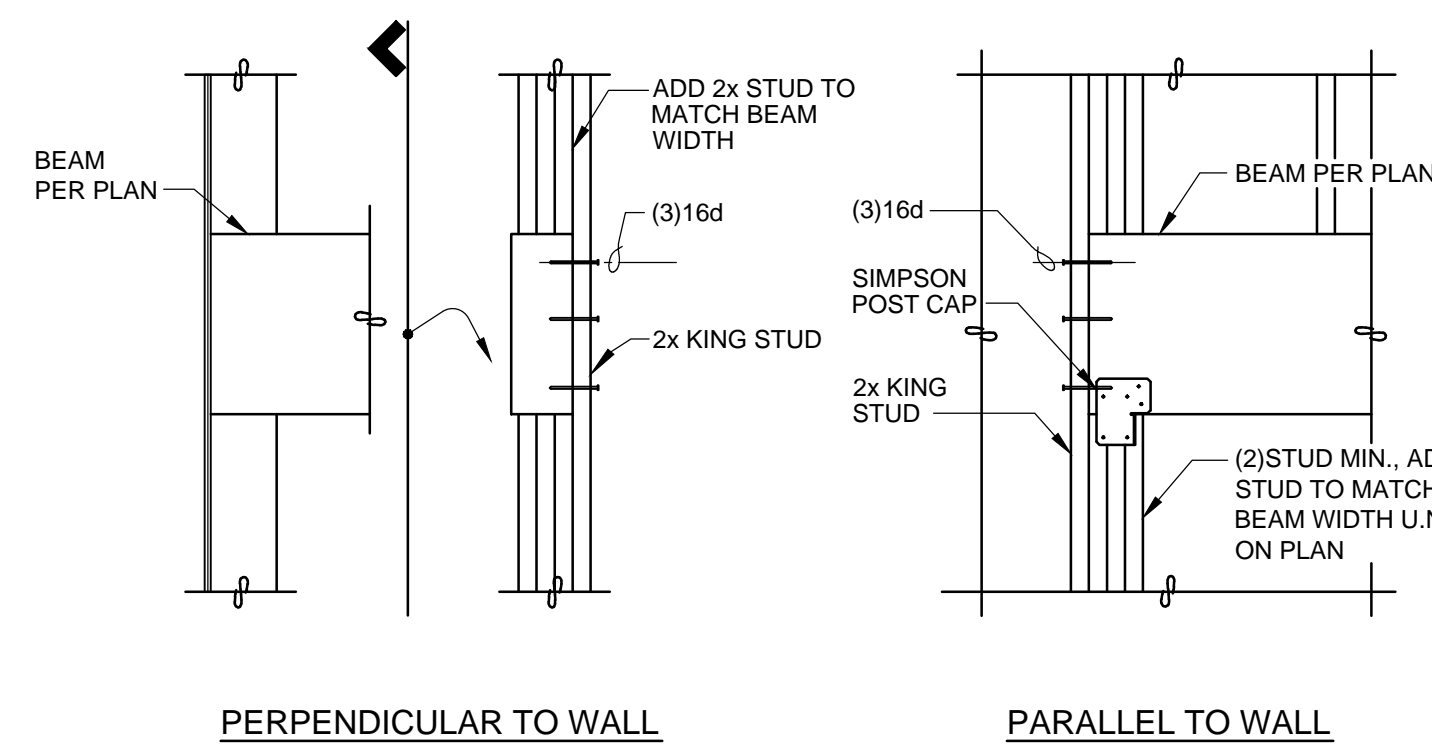

TYPICAL BEAM TO WALL CONNECTION

6 SECTION


3/4" = 1'-0"

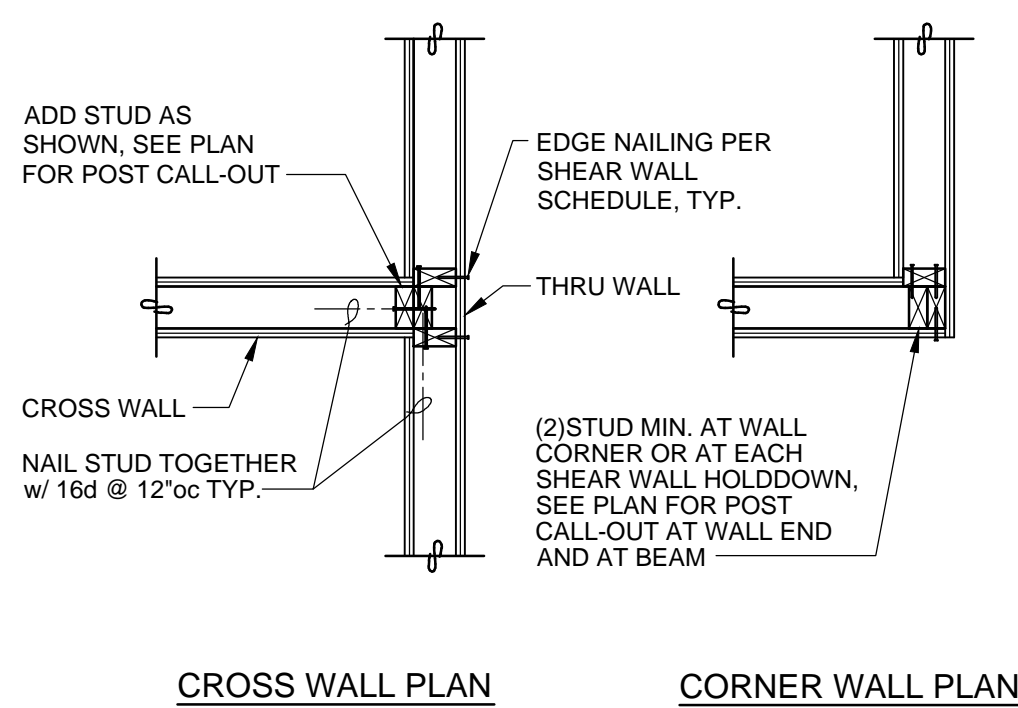

TYPICAL STUD WALL INTERSECTION


7 SECTION

3/4" = 1'-0"

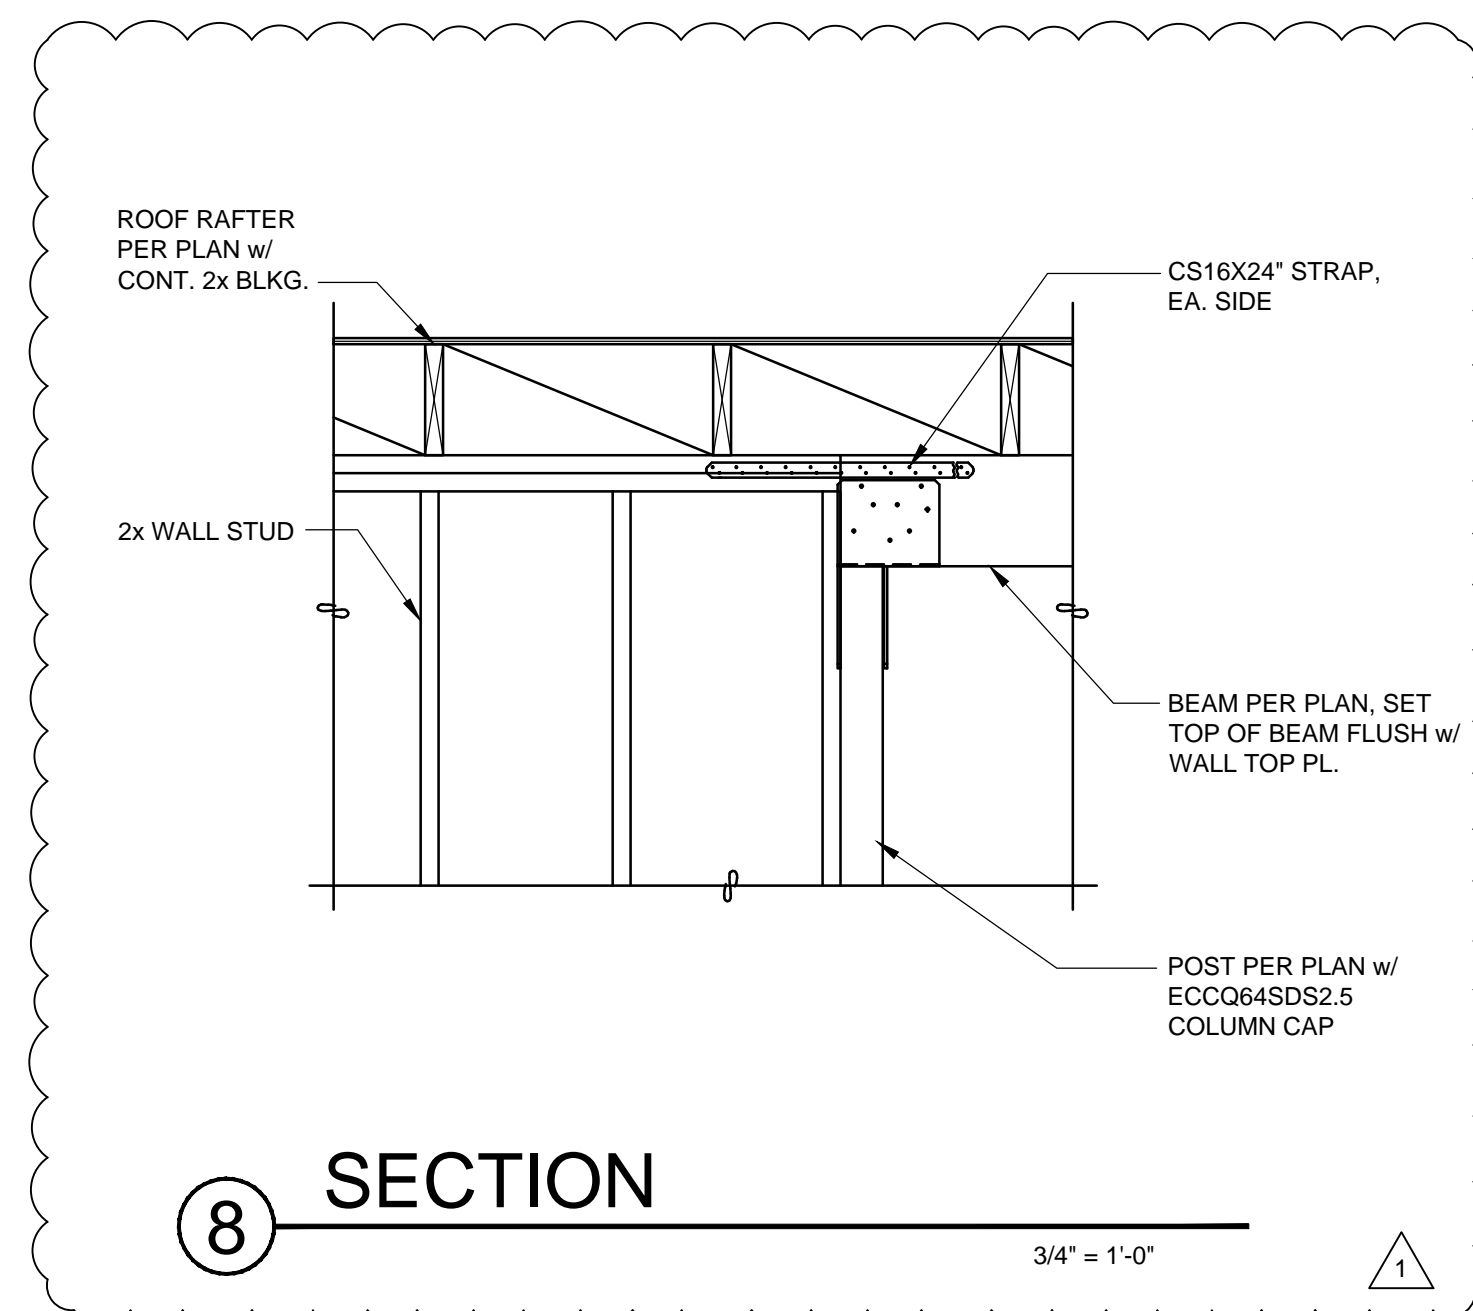

8 SECTION

3/4" = 1'-0"

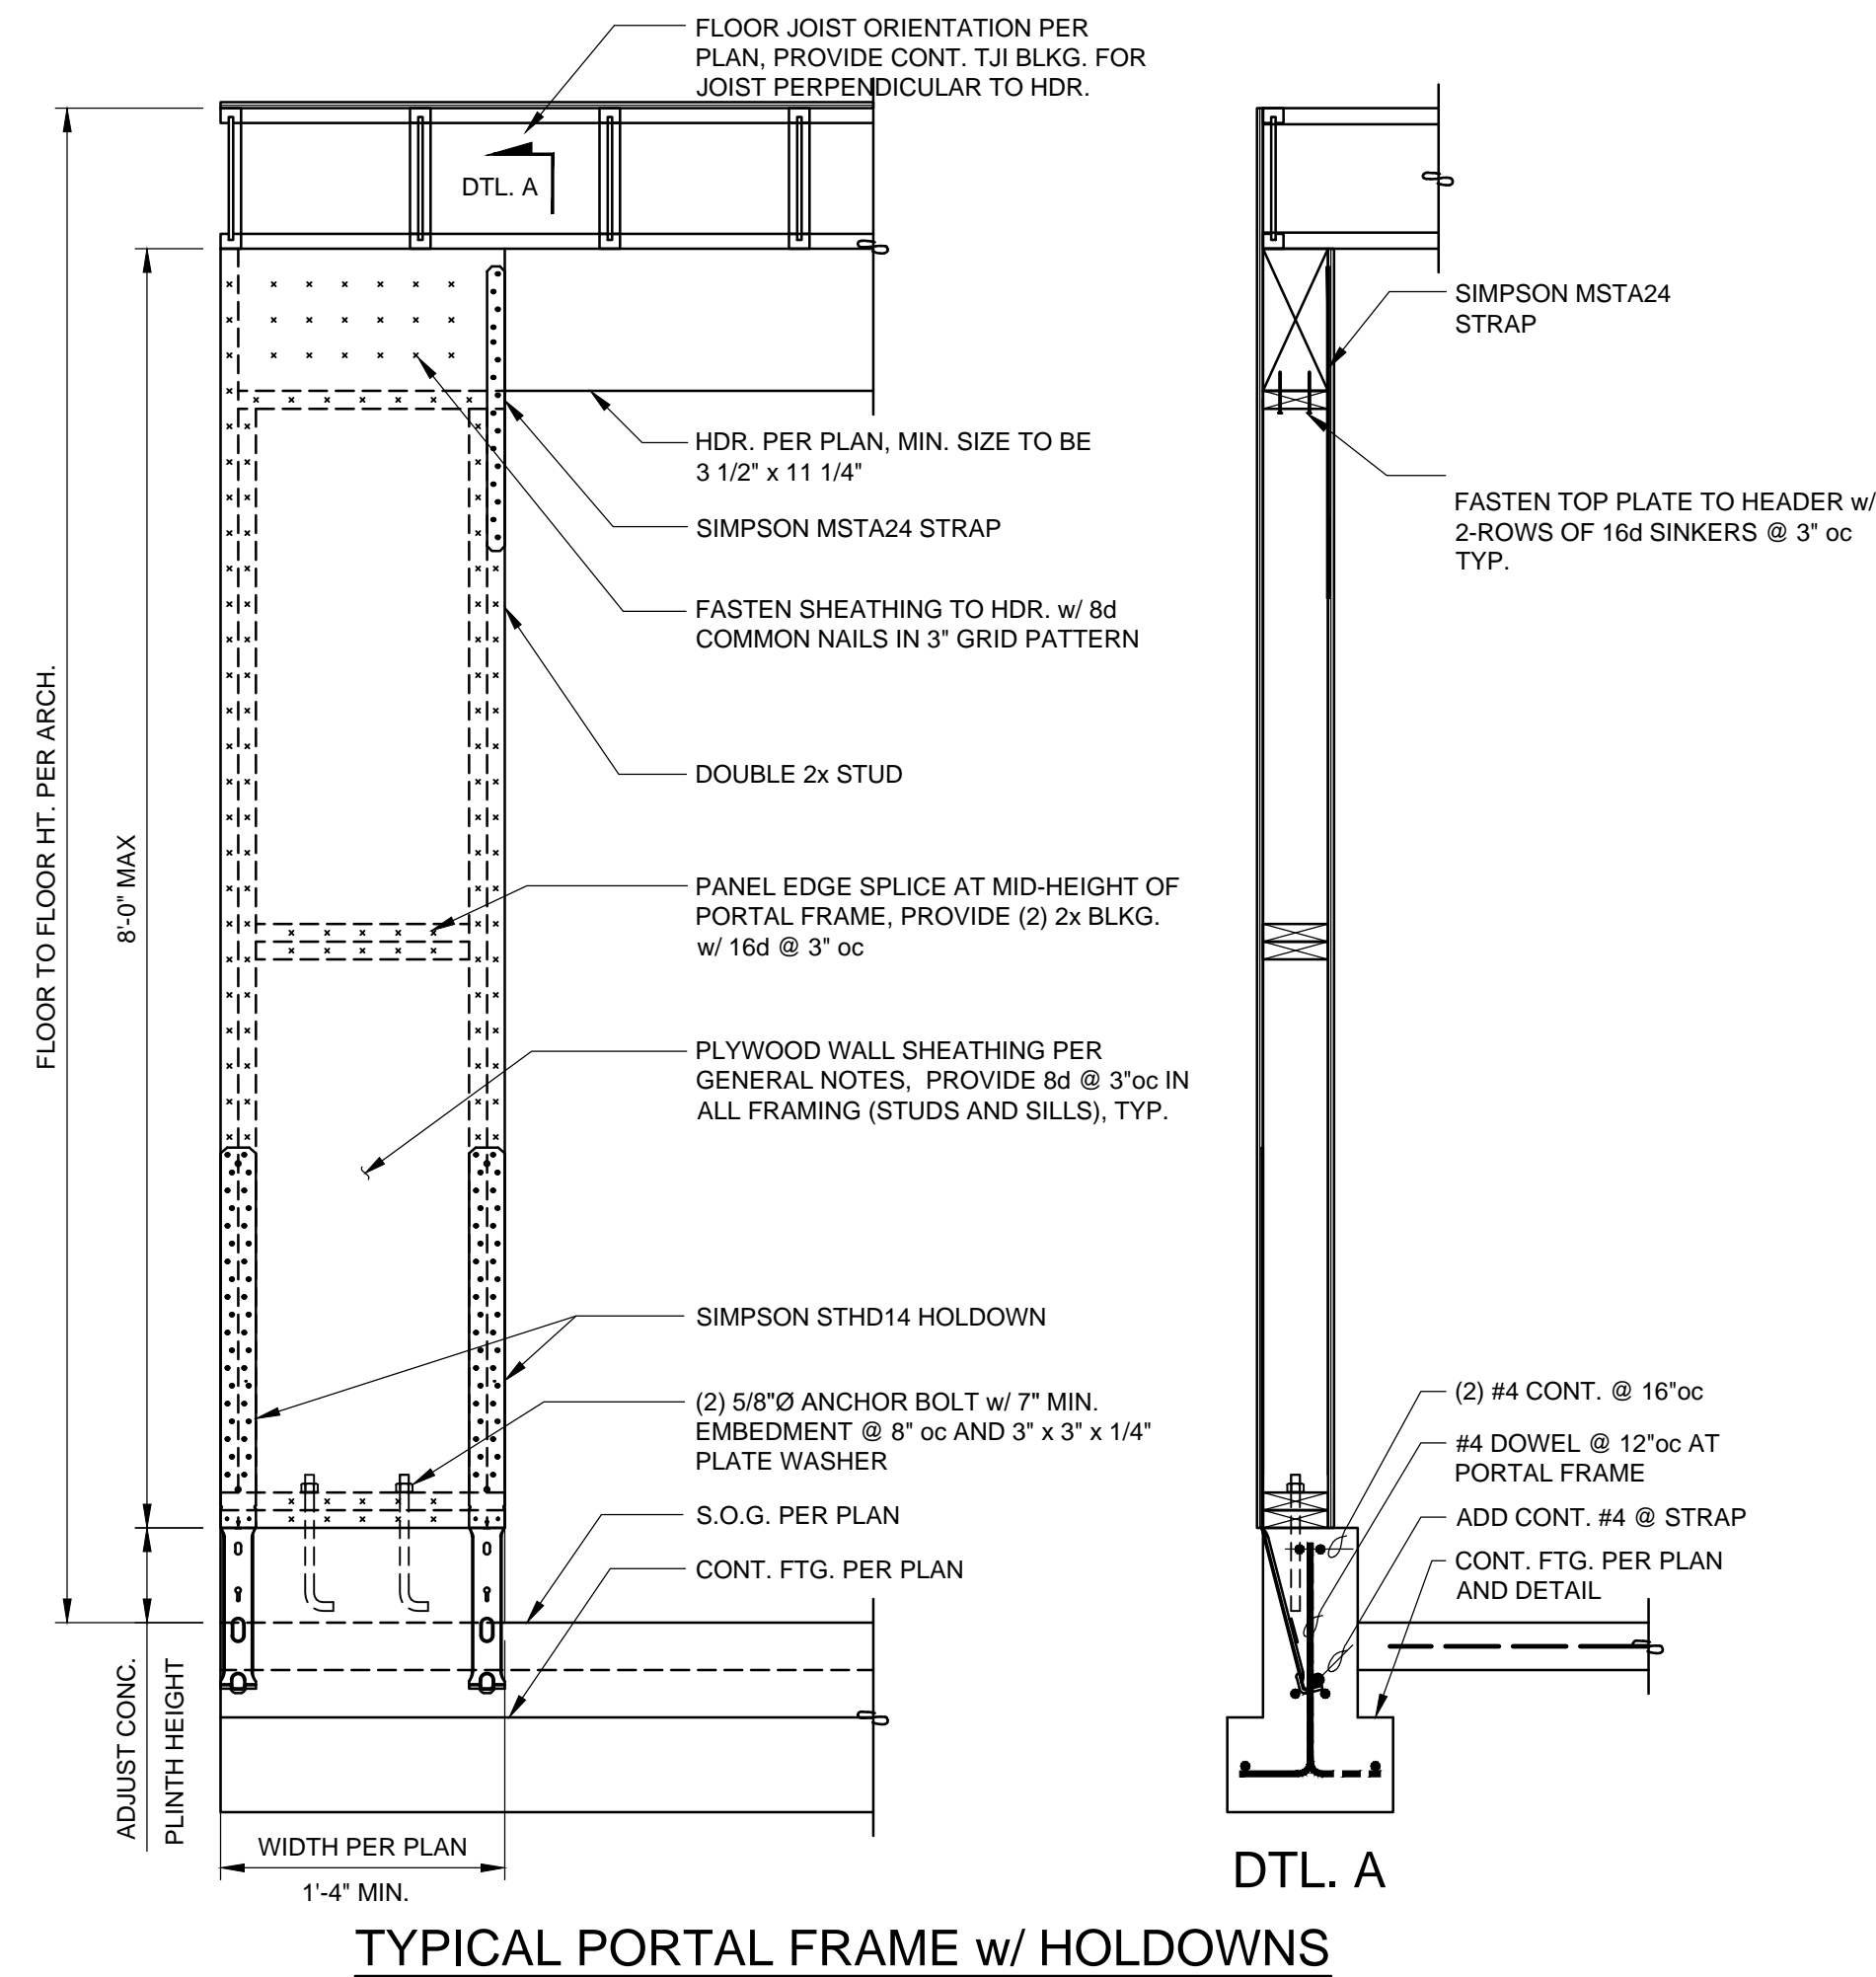

TYPICAL PORTAL FRAME w/ HOLD-DOWNS

9 SECTION

3/4" = 1'-0"



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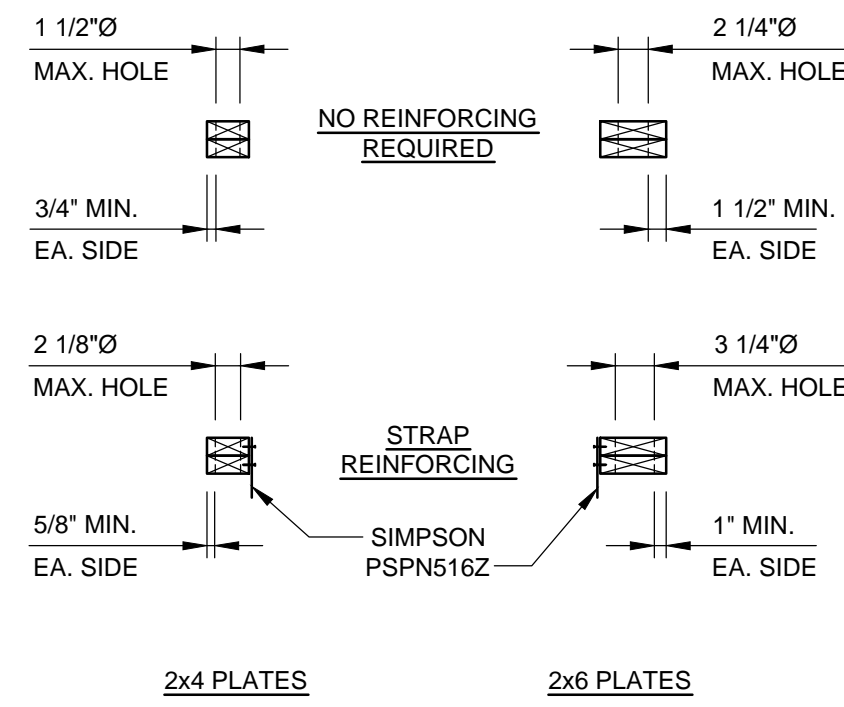
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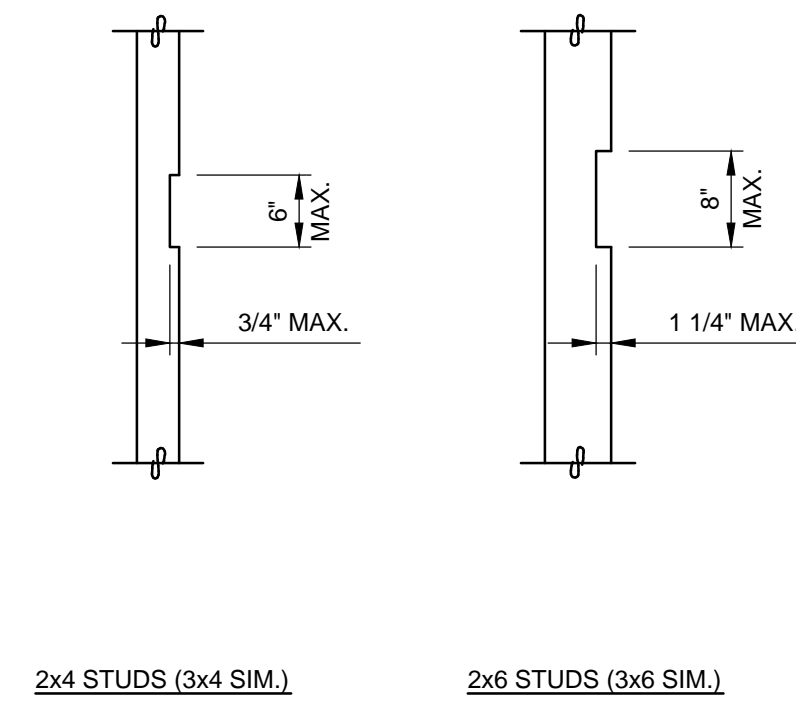
S2.3



ALLOWABLE HOLES THROUGH TOP PLATES

1 SECTION


NOTE:
1) AT BOTTOM PLATES, FOLLOW GUIDELINES SHOWN, EXCEPT USE SIMPSON CS16 X 2'-0" STRAP



ALLOWABLE NOTCHES IN STUDS

2 SECTION


NOTE:
1) NOTCHES SHALL NOT OCCUR IN MORE THAN (2) SUCCESSIVE STUDS

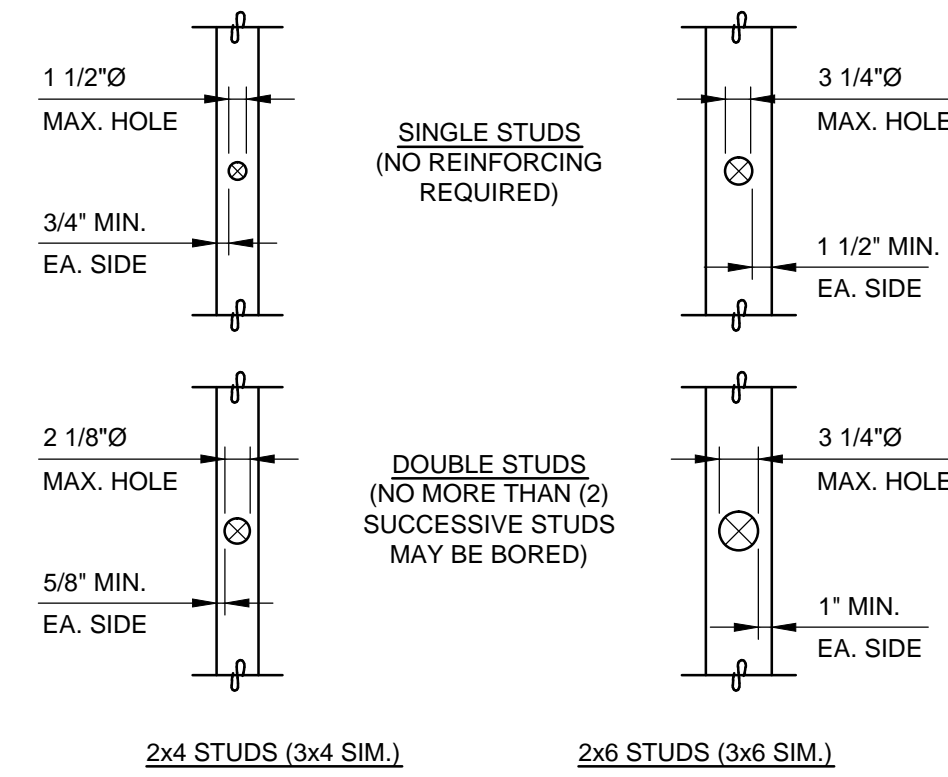

ALLOWABLE HOLES THROUGH STUDS

3 SECTION


NOTE:
1) NOTCHES SHALL NOT OCCUR IN MORE THAN (2) SUCCESSIVE STUDS

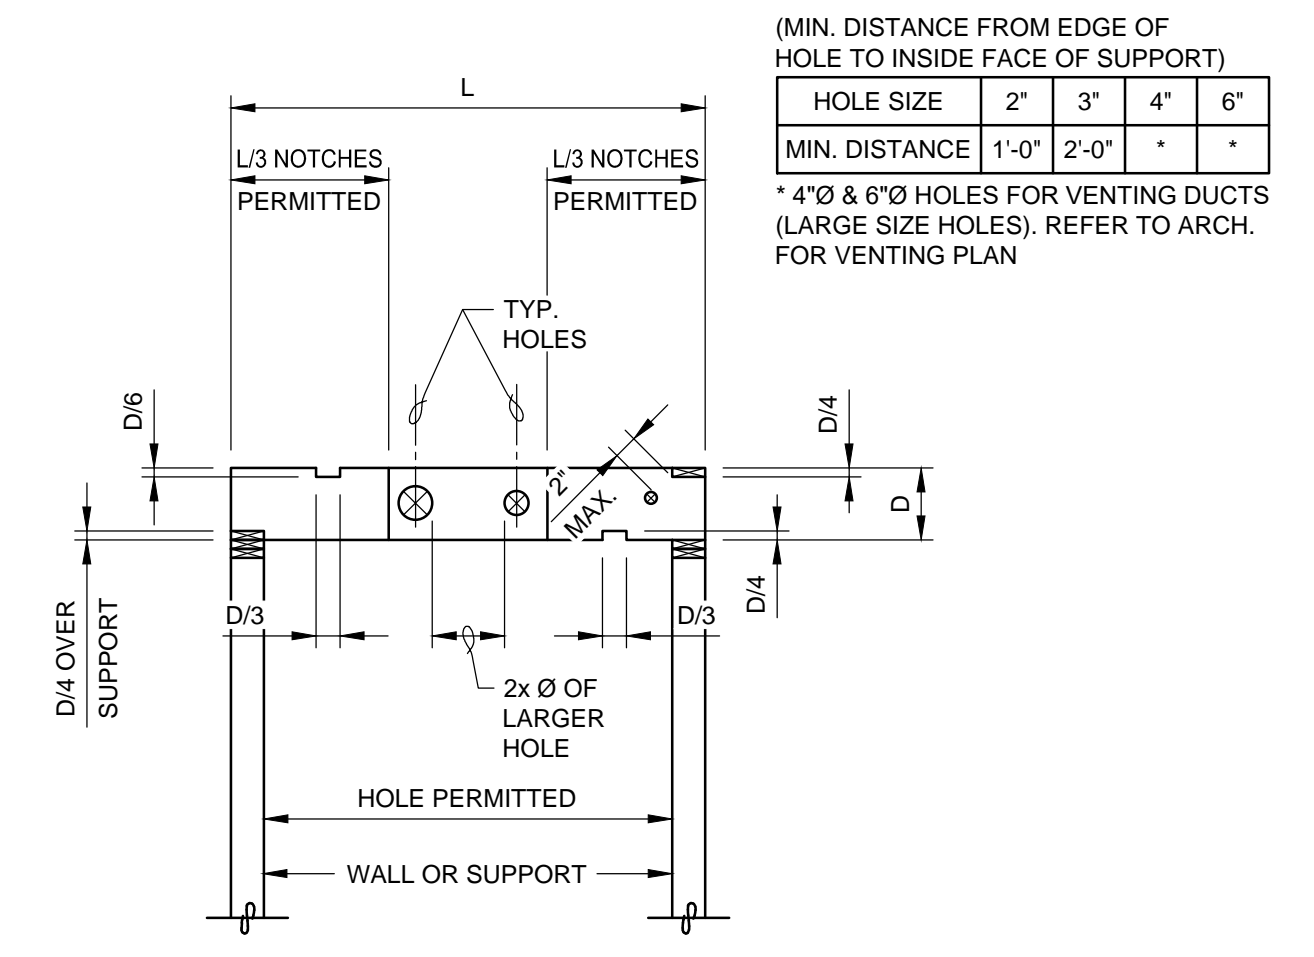

ALLOWABLE CUTTING IN LSL, LVL, OR PSL MEMBERS

4 SECTION


3/4" = 1'-0"

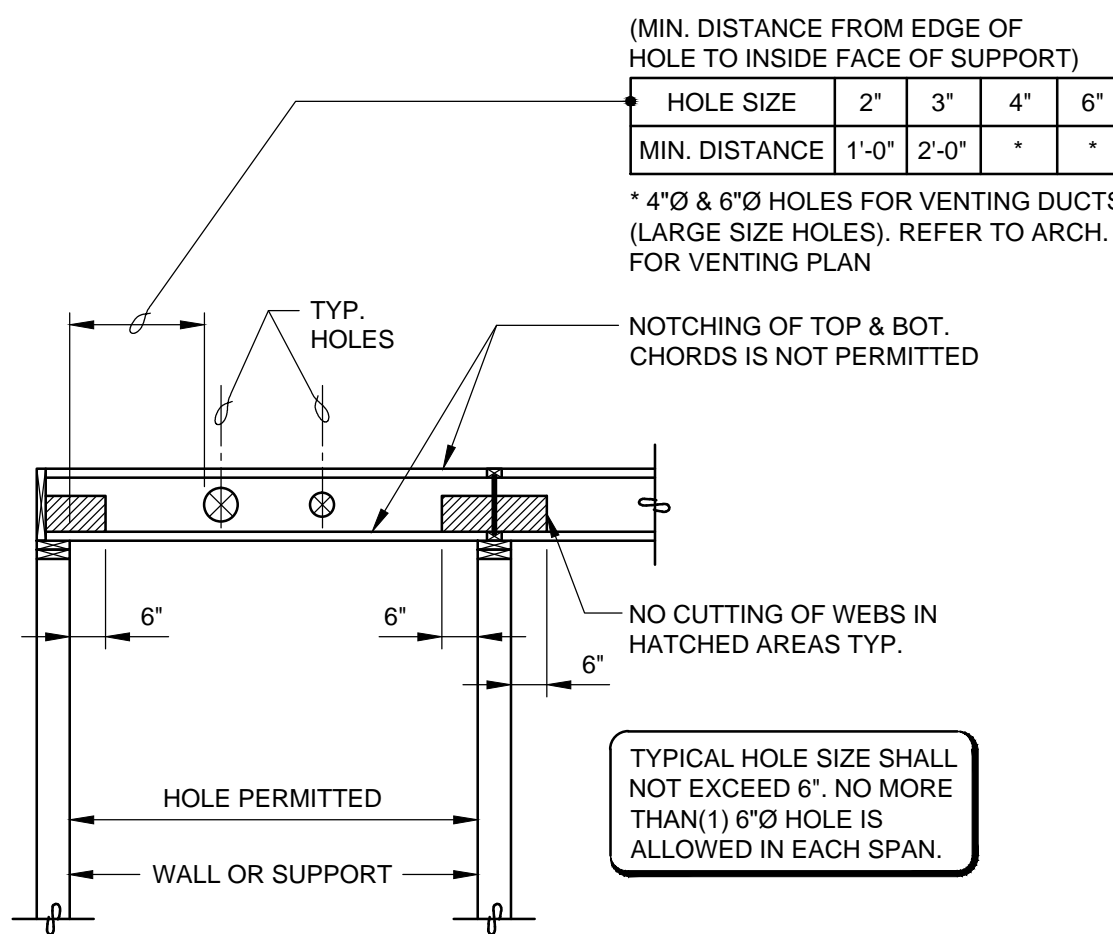

ALLOWABLE CUTTING IN WEB JOIST MEMBERS

5 SECTION


3/4" = 1'-0"

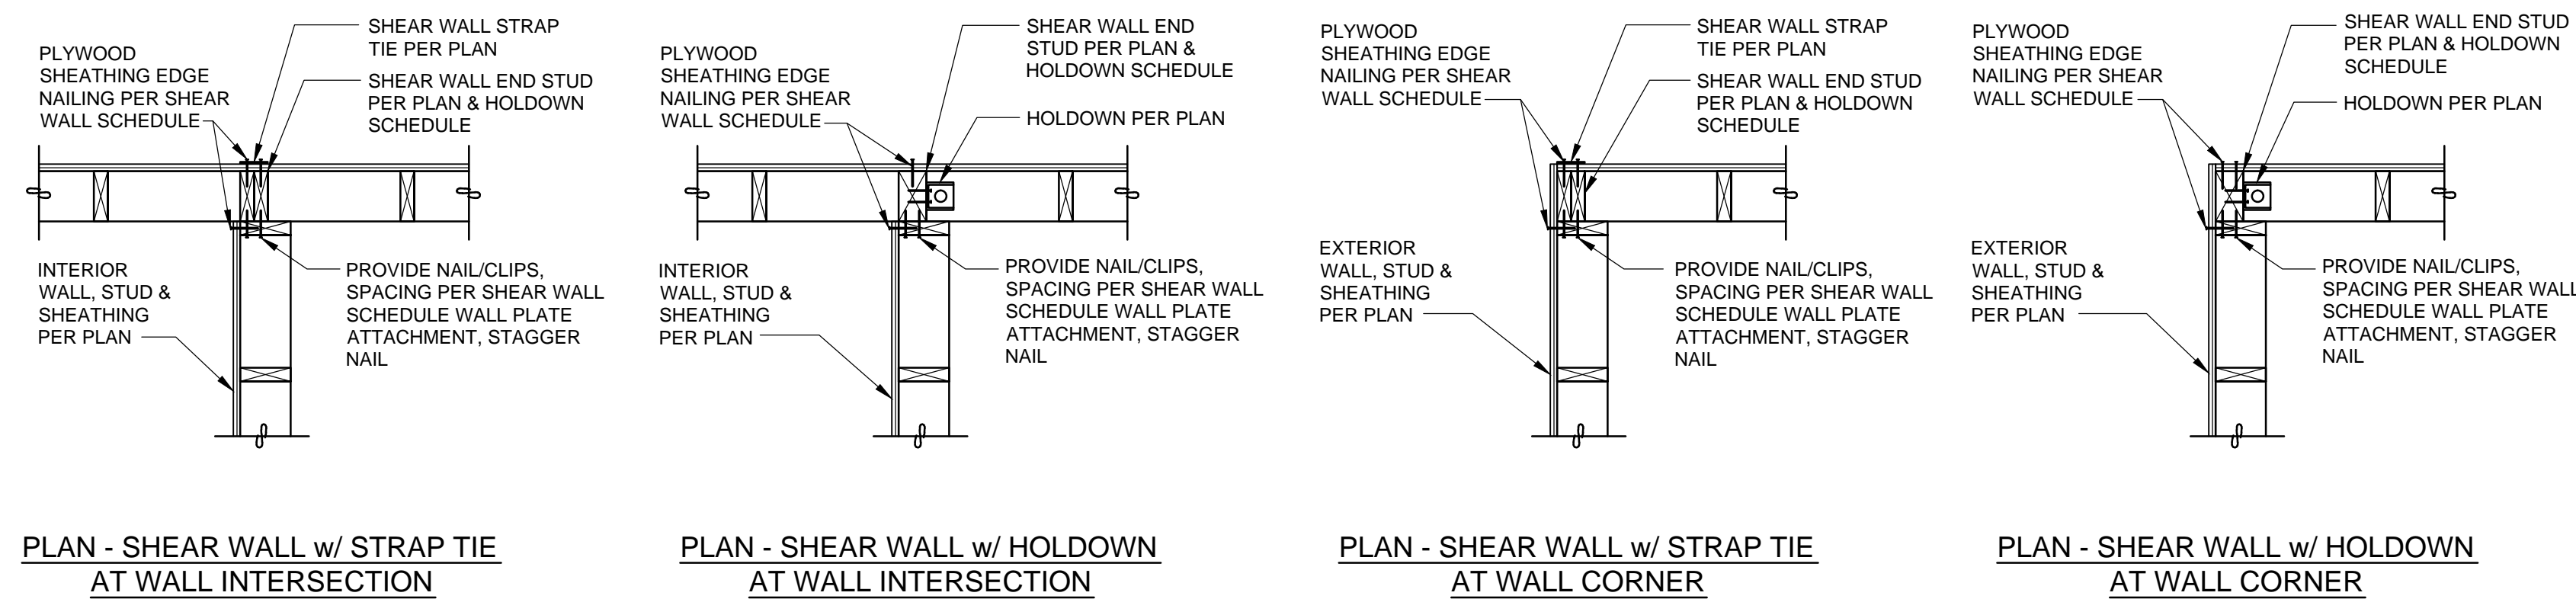

TYPICAL SHEAR WALL END STUD AT WALL INTERSECTION & CORNER

6 SECTION


3/4" = 1'-0"

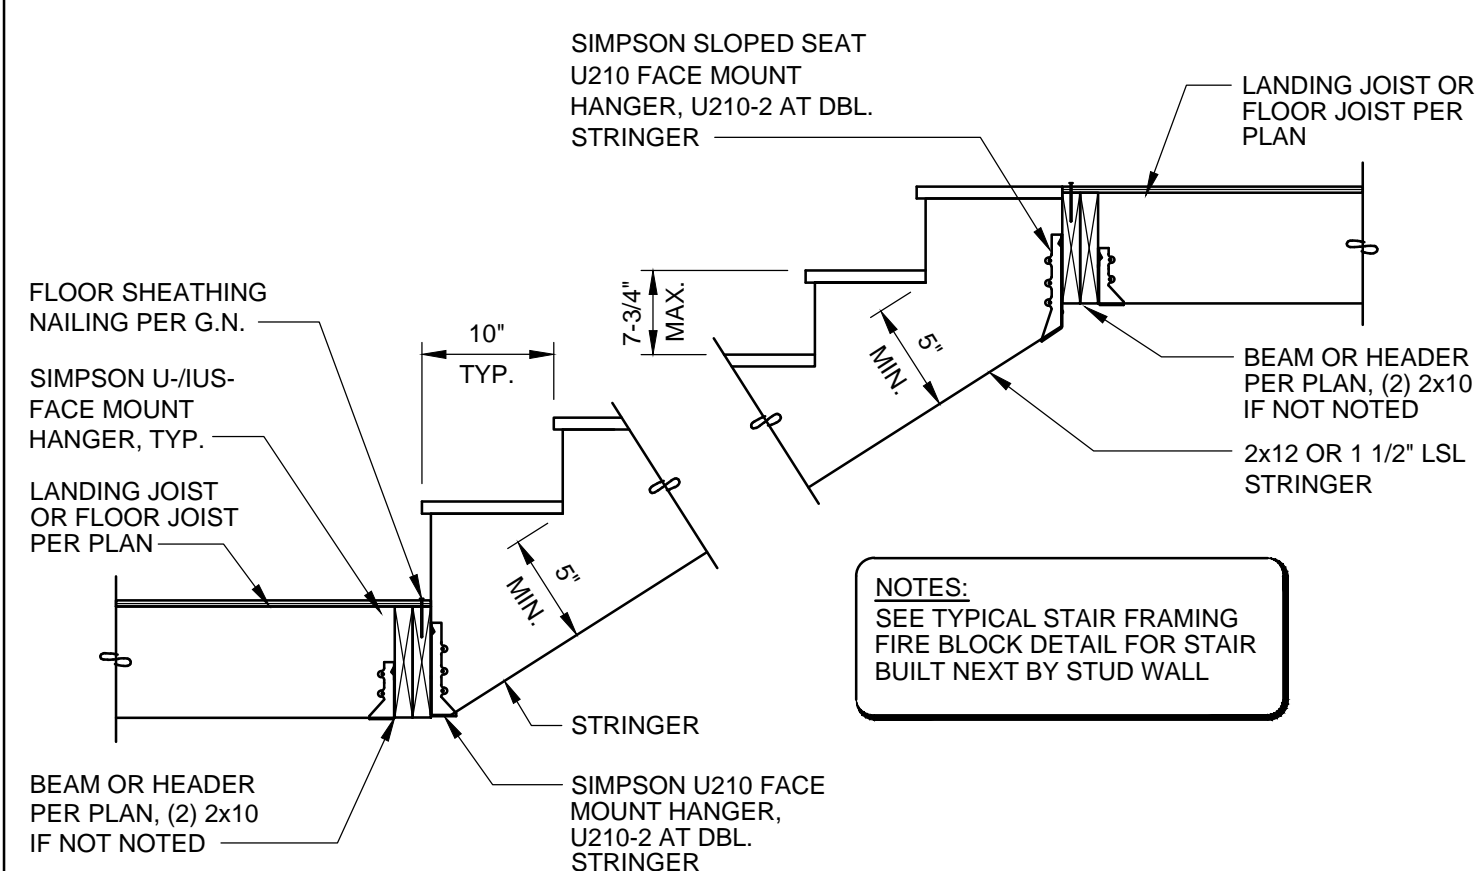

TYPICAL STAIR FRAMING

7 SECTION


3/4" = 1'-0"

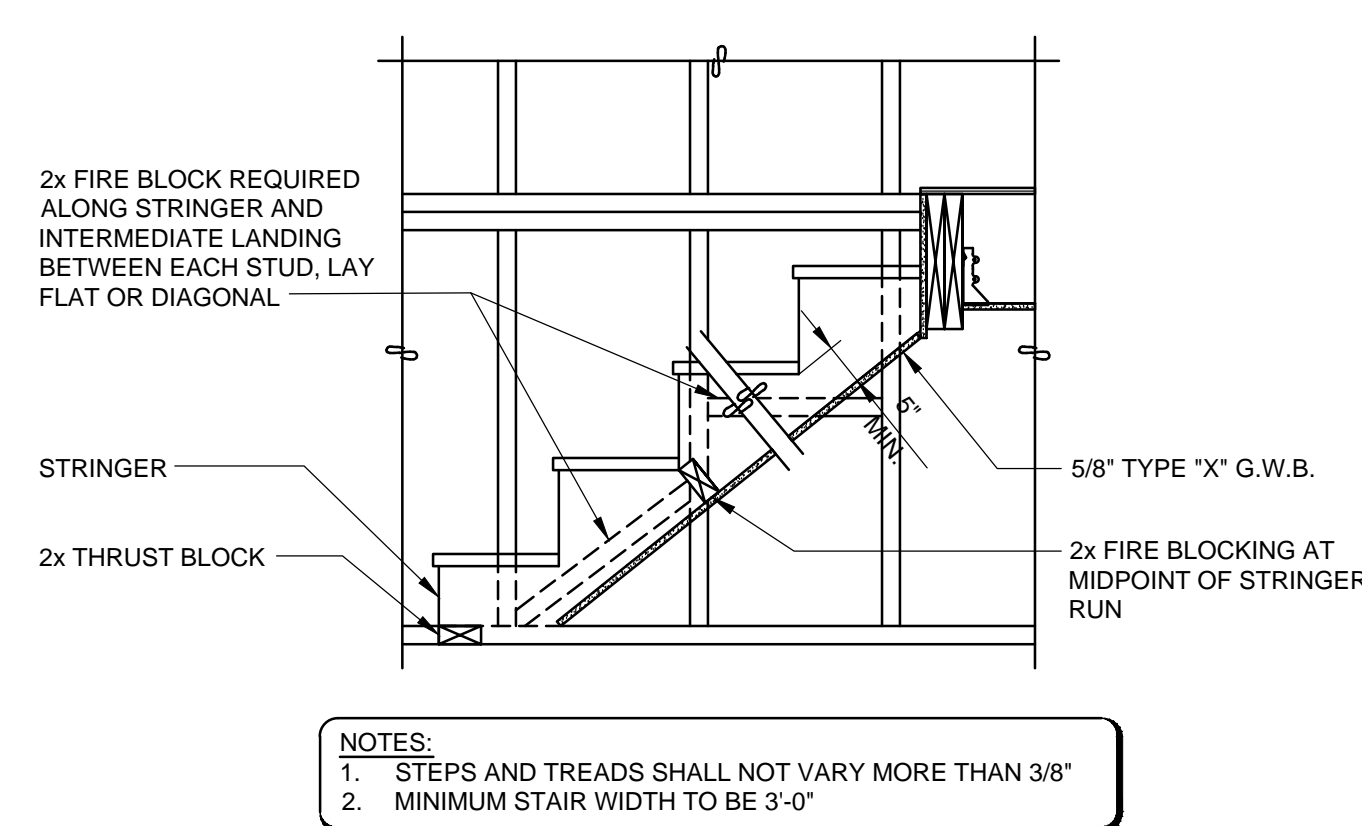

TYPICAL STAIR FIRE BLOCK AT FULL HT. WALL


8 SECTION

3/4" = 1'-0"

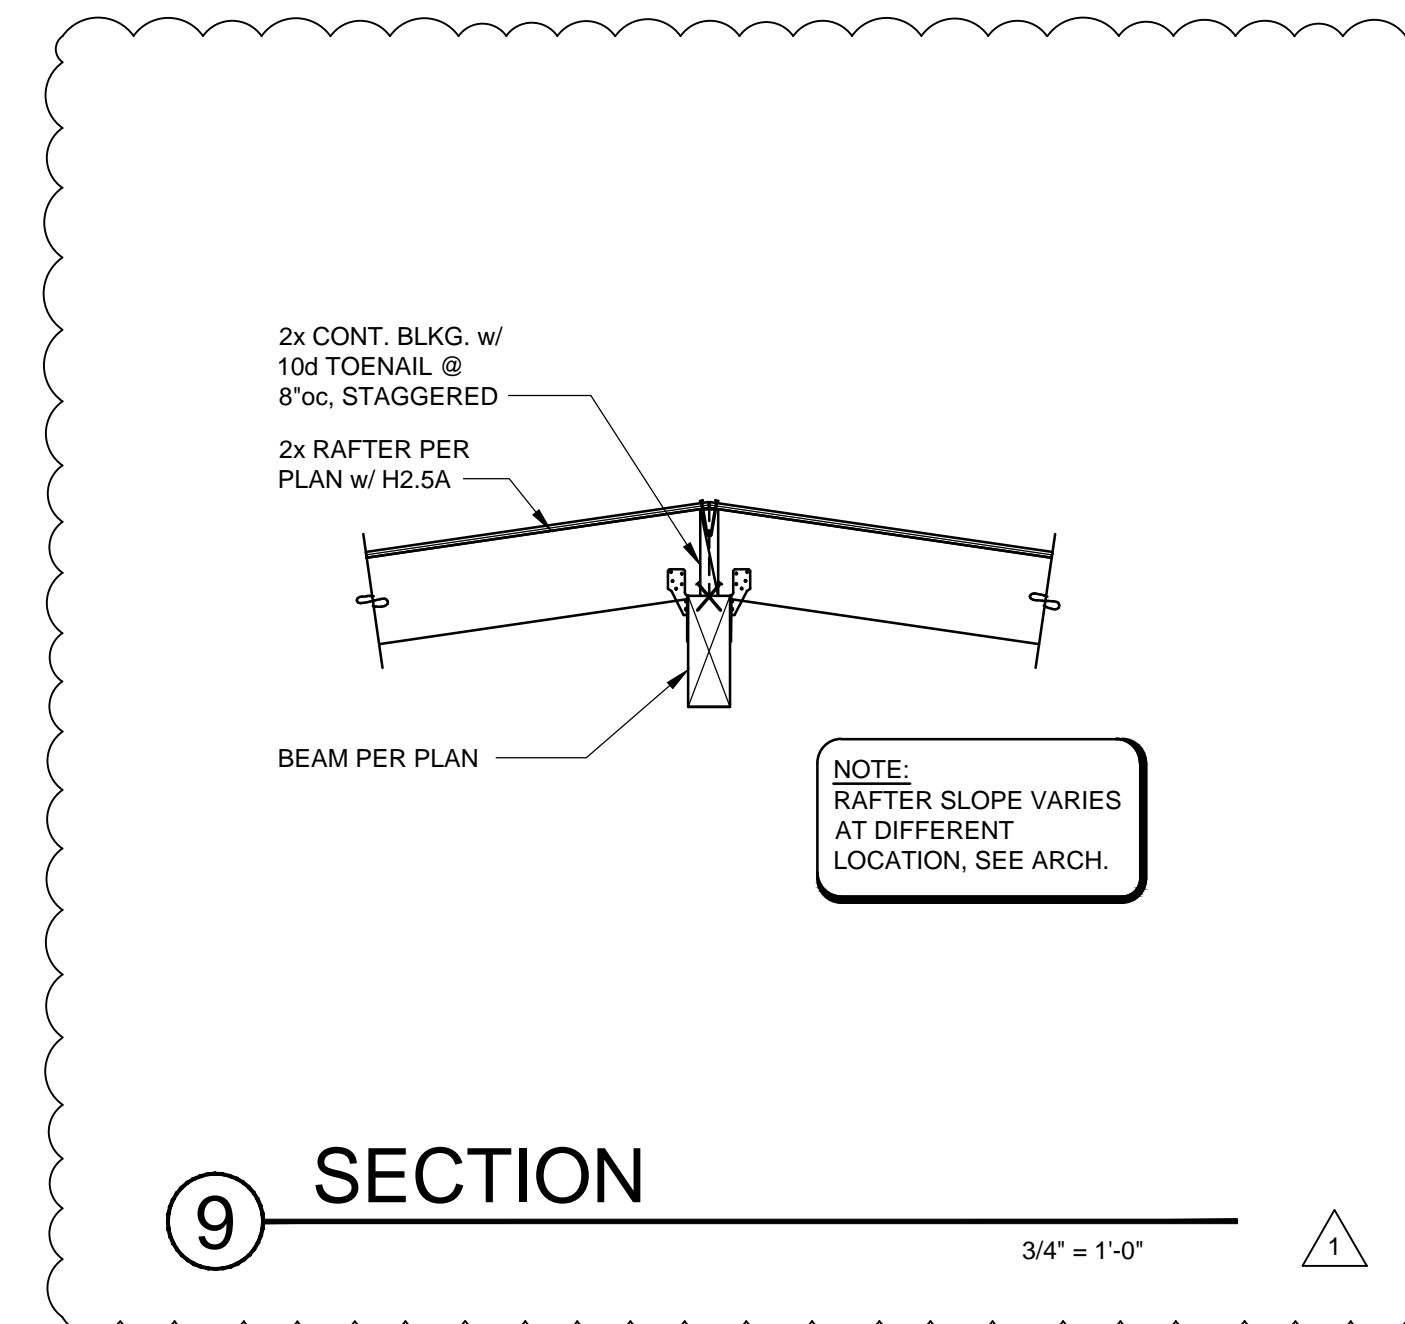

9 SECTION

3/4" = 1'-0"

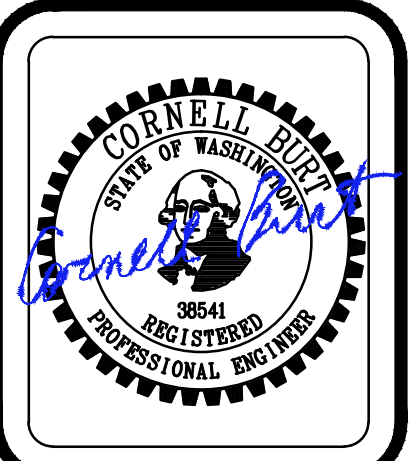

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